
# **BUILDING RENOVATIONS FOR:** HENRY COUNTY HIGHWAY DEPT.

### 1343 BALES ROAD NAPOLEON, OHIO 43545

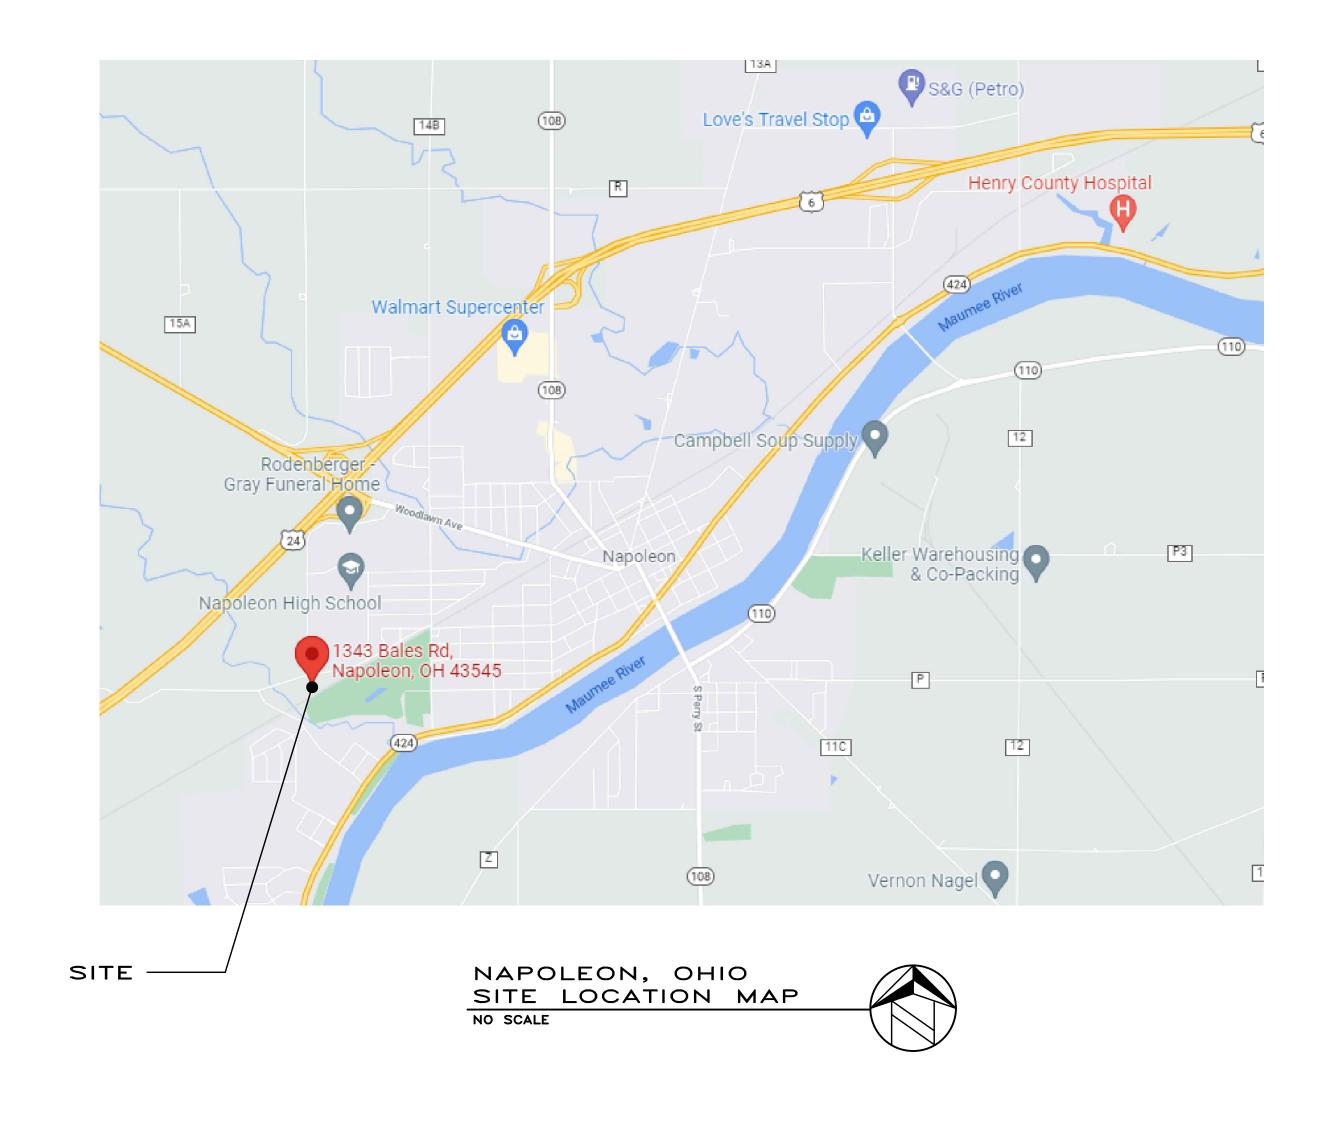

P.E.M.B. PRE-ENGINEERED METAL BUILDING DWG. SYMBOLS & NOTATIONS

PRESERVATIVE TREATED

ROUGH OPENING

F.R.T. FIRE RETARDANT TREATED

DOOR NUMBER

WINDOW DESIGNATION

**KEYNOTE DESIGNATION** 

**REVISION NUMBER** 

ELECTRICAL PANEL

FLOOR CLEANOUT

**GENERAL CONTRACTOR** 

PLUMBING CONTRACTOR

MECHANICAL CONTRACTOR

**ELECTRICAL CONTRACTOR** 


ABOVE FINISHED FLOOR

FINISHED FLOOR ELEVATION


UNLESS NOTED OTHERWISE

PROTECTION CONTRACTOR


DOWNSPOUT

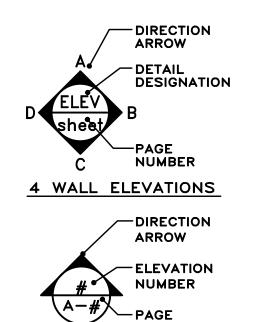

WALL ELEVATION SYMBOL

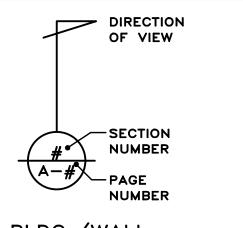

BLDG./WALL SECTION SYMBOL

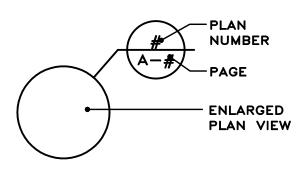

ENLARGED PLAN SYMBOL

CROSS REFERENCES

IT SHALL BE THE RESPONSIBILITY OF THE LEAD CONTRACTOR AND OF EACH SUB CONTRACTOR TO THOROUGHLY REVIEW THE ENTIRE SET OF DRAWINGS AND PROJECT MANUAL (OR SPECIFICATIONS) IN ORDER TO FAMILIARIZE THEMSELVES WITH ITEMS BEING PROVIDED BY AND WORK BEING PERFORMED BY ALL OTHER TRADES IN ADDITION TO ITEMS BEING PROVIDED BY AND WORK BEING PERFORMED BY HIS/HER RESPECTIVE TRADE.

ARCHITECT/ENGINEER

**TECHNICON DESIGN GROUP, INC.** 1800 N. PERRY ST., SUITE 102

**KEVIN NIESE, PROJECT MANAGER** 

GILLIAN STECHSCHULTE, PROJECT ARCHITECT

**OTTAWA, OHIO 45875** 

FAX: (419) 523-9441

CONTACT:


PHONE: (419) 523-5323

BUILDING CODES

BUILDING CODE PLUMBING CODE MECHANICAL CODE ELECTRICAL CODE ENERGY CODE **ACCESSIBILITY** 

2017 OBC 2017 OPC 2017 OMC 2017 NEC ASHRAE 90.1 (2010) ICC A117.1 (2009)

ALL CONTRACTORS SHALL COORDINATE WORK BETWEEN TRADES.

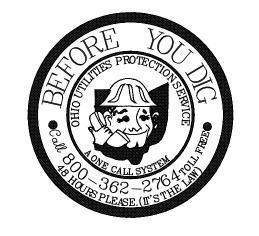



| ISSUED DATE                 |
|-----------------------------|
| 12-22-21 OWNER REVIEW       |
| 02-07-22 OWNER REVIEW       |
| 02-14-22 OWNER/CONTR REVIEW |
| D2-24-22 FOR BIDS/PERMITS   |
|                             |
|                             |
|                             |
|                             |
|                             |
|                             |

DRAWING INDEX

CODE COMPLIANCE

**ARCHITECTURAL** 

DETAILS

ALTERNATE G-1

SITE LOCATION MAP

DEMOLITION PLAN FLOOR PLAN AND DETAILS

ROOF PLAN AND DETAILS

PLUMBING SPECIFICATIONS

BUILDING SECTIONS AND DETAILS
BUILDING SECTIONS AND DETAILS

CODE COMPLIANCE PLAN, DESIGN LOAD DATA AND CODE COMPLIANCE DATA

EXTERIOR BUILDING ELEVATIONS, DOORS AND

PLUMBING FLOOR PLAN
SANITARY ISOMETRIC, SCHEDULE AND DETAILS


License #ARC1516394 Expiration Date 12/31/23

1800 N PERRY STREET, SUITE 102, OTTAWA, OH 45875 P:419.523.5323 www.technicondesigngroup.com

#### SCOPE OF WORK:

REMOVAL OF ALL EXTERIOR FACE BRICK AND METAL WALL PANELS AT PERIMETER AND INSTALL NEW METAL WALL PANELS OVER EXISTING INSULATED PANELS. REMOVAL OF 6" CMU'S AT NORTH, EAST AND WEST WALLS OF GARAGE 101. REMOVAL AND REPLACE CONCRETE FLOORS IN GARAGE 101 AND SHOP 102 AREAS. INSTALLATION OF NEW TRENCH DRAIN AND OIL INTERCEPTOR. REPLACE ALL EXTERIOR DOORS AND WINDOWS. NEW INSULATION AND PVC ROOF. ALL ROOF FRAMING MEMBERS IN GARAGE 101 AND SHOP 102 TO BE PAINTED. SECTIONS OF EXTERIOR 12" CONCRETE WALL TO BE REPLACED. INSTALLATION OF NEW RECESSED FLOOR LIFT. LIFT PROVIDED BY OWNER.

NEW RENOVATIONS DO NOT OBSTRUCT ANY EXISTING PATHS OF EGRESS. NO NEW INTERIOR WALLS, NO REMOVAL OF EXISTING DOORS. ONE (1) NEW EXTERIOR DOOR TO BE ADDED.

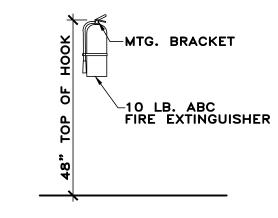

FIRE EXTINGUISHER

MOUNTING DETAIL

G101 SCALE: N.T.S.

#### SYMBOLS LEGEND

# NOMINAL EXIT CAPACITY OF EACH DOOR OR PAIR OF DOORS (ACCESSIBLE)

ROOM OCCUPANT LOAD

EXIT/EMERGENCY LIGHT W/ REMOTE EGRESS

→ EXIT/EMERGENCY LIGHT W/ REMO

→ EXIT/EMERGENCY LIGHT

→ EXIT/EMERGENCY

EXIT/EMERGENCY LIGHT - DIRECTIONAL

EMERGENCY LIGHT


- DIRECTION OF EGRESS TRAVEL

ORIGIN OF EGRESS TRAVEL

ORIGIN OF MAXIMUM TRAVEL DISTANCE

#### CODE COMPLIANCE KEYNOTE LEGEND


(1) EXISTING FIRE EXTINGUISHER ON MTG. BRACKET. DETAIL 1/G101.

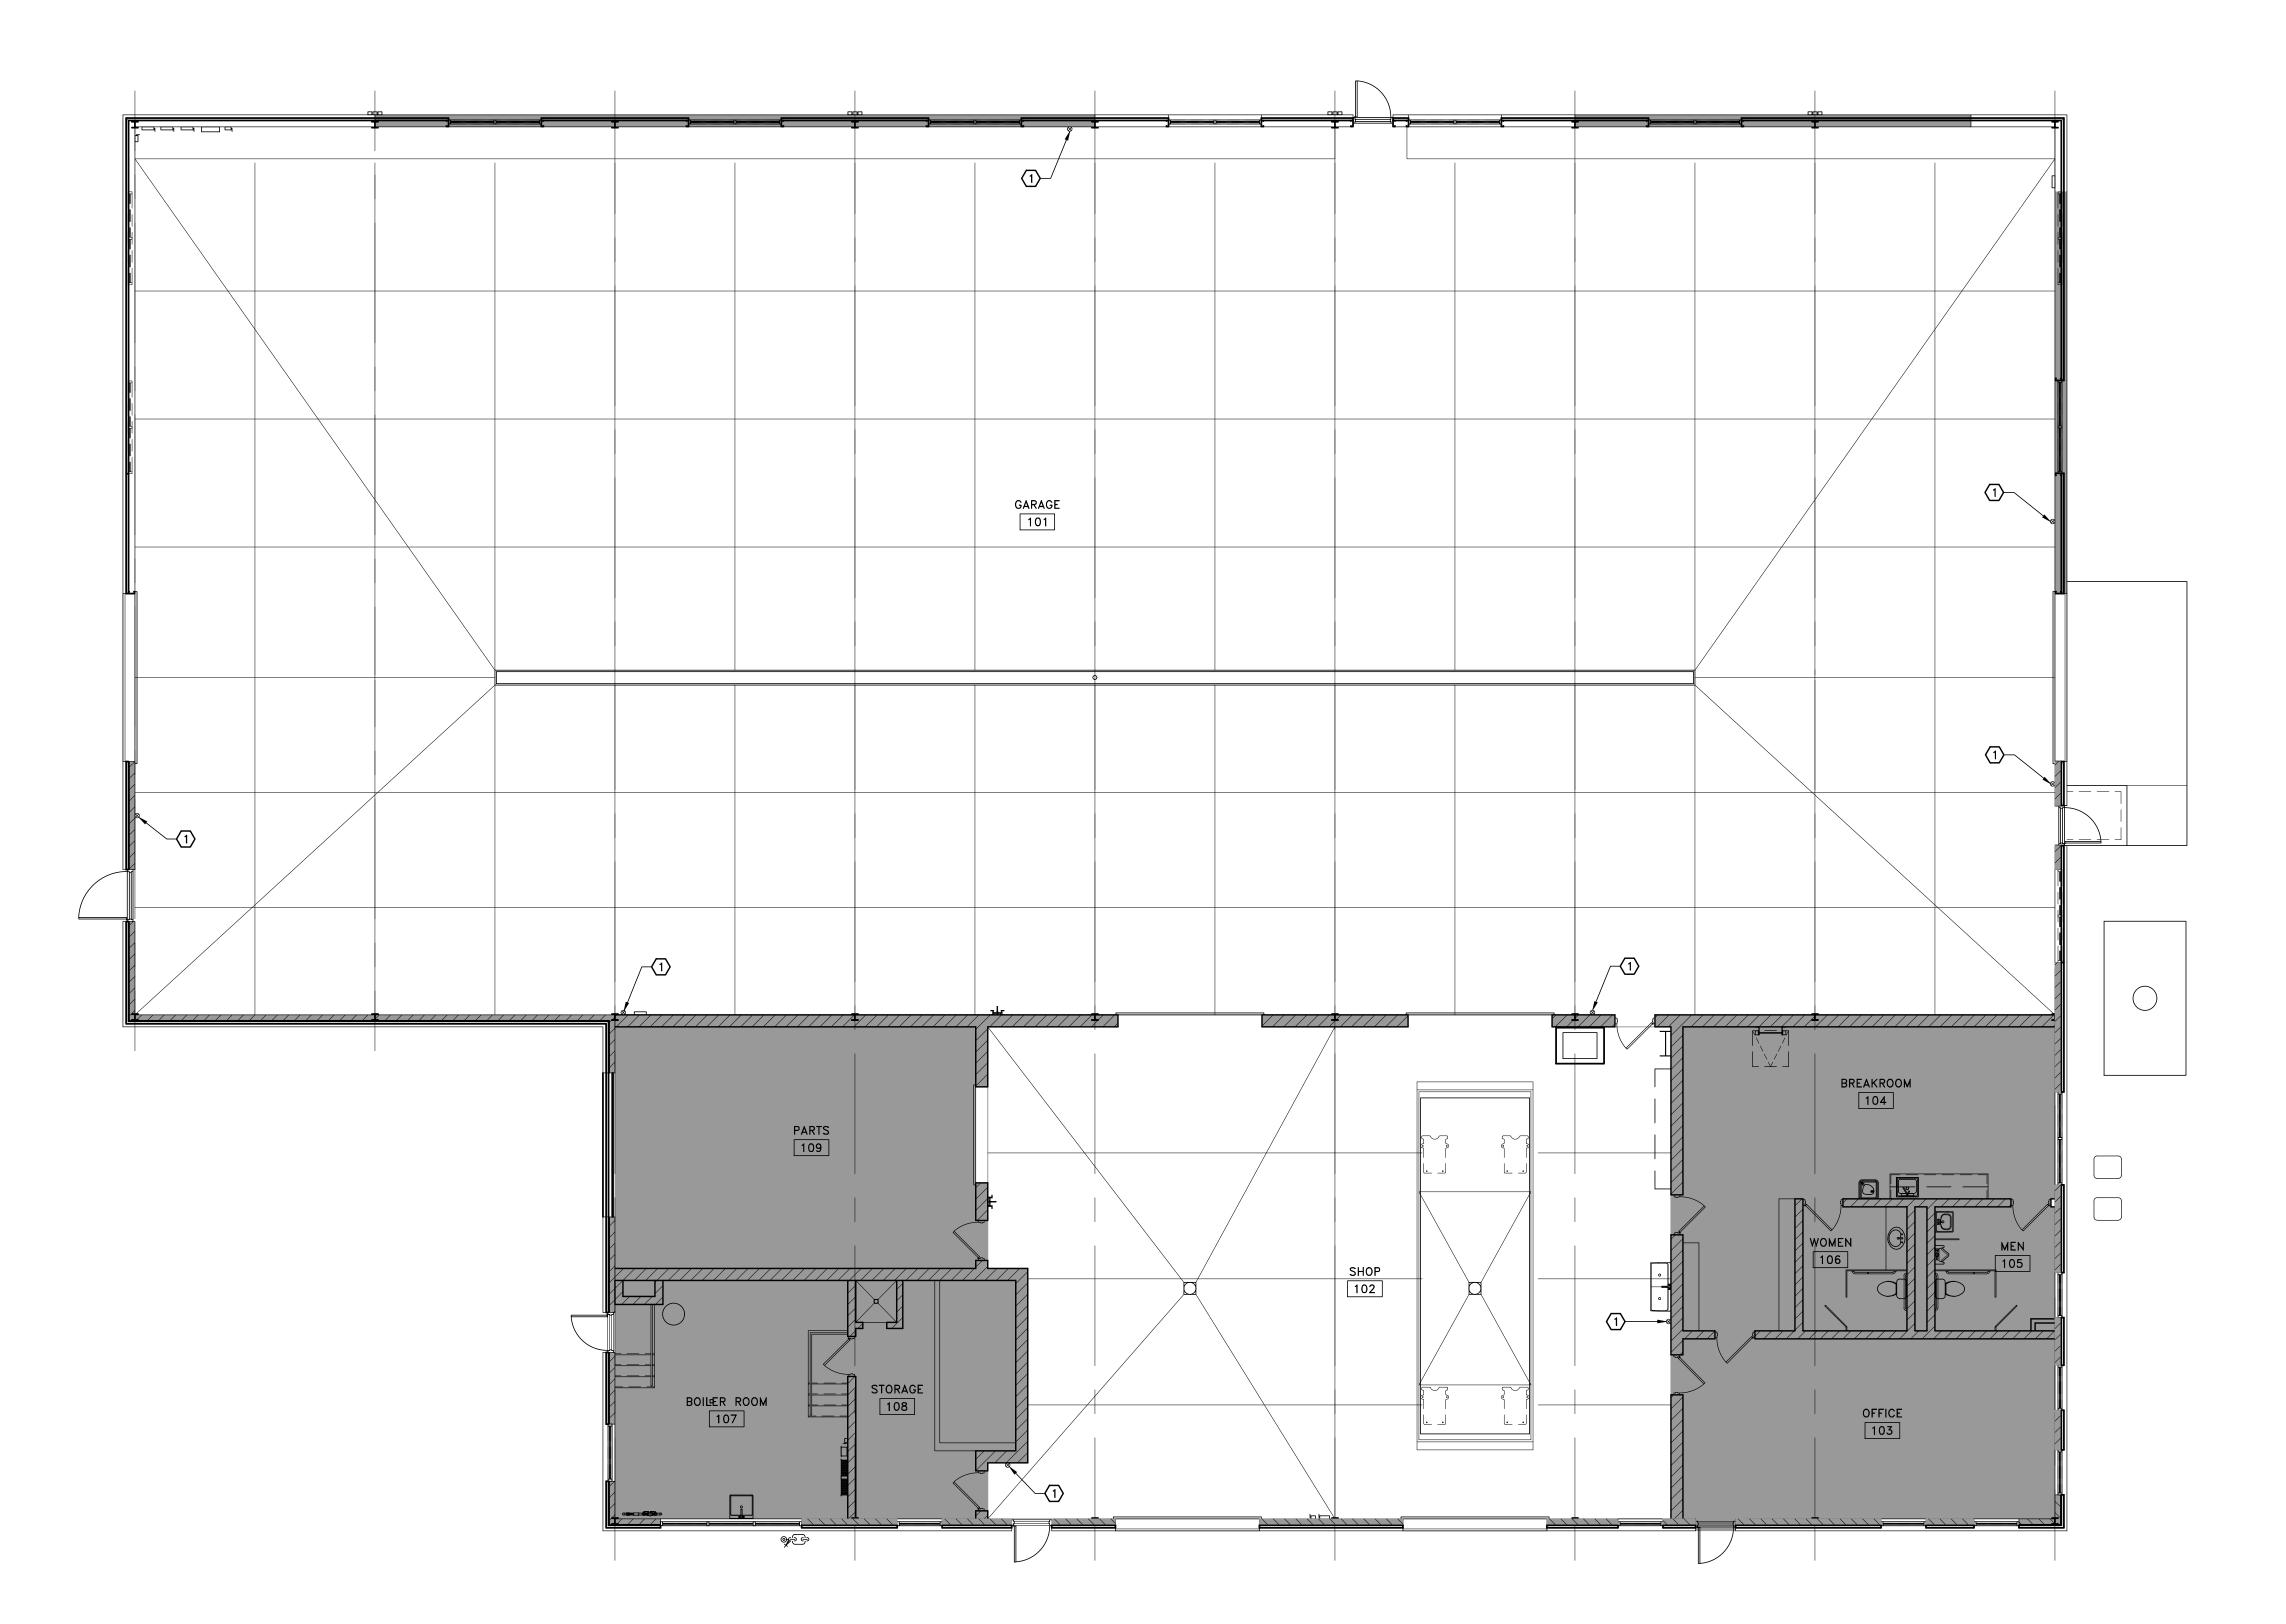

APPLICABLE BUILDING CODES

BUILDING CODE
PLUMBING CODE
MECHANICAL CODE
ELECTRICAL CODE
ENERGY CODE
ACCESSIBILITY

2017 OBC 2017 OPC 2017 OMC 2017 NEC ASHRAE 90.1 (2010) ICC A117.1 (2009)

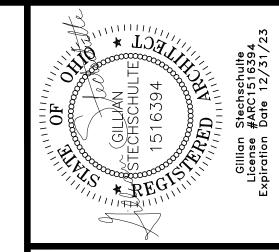

Son Group

Technico Design (

|                    | 2017 OBC CODE CO            | OMPLIANCE DATA                          |  |
|--------------------|-----------------------------|---|--|
| OWNER              | NAME                        | HENRY COUNTY HIGHWAY<br>DEPARTMENT      |  |
|                    | ADDRESS                     | 1343 BALES ROAD NAPOLEON,<br>OHIO 43545 |  |
|                    | CONTACT                     | STEVE EBERLE                            |  |
|                    | PHONE                       | 419-592-5946                            |  |
|                    | EMAIL                       | seberle@henrycountyengineer.com         |  |
|                    | NAME                        | TECHNICON DESIGN GROUP, INC.            |  |
|                    |                             | 1800 NORTH PERRY ST.                    |  |
|                    | ADDRESS                     | SUITE 102                               |  |
|                    |                             | OTTAWA, OHIO 45875                      |  |
| SUBMITTER          | PHONE                       | 419-523-5323                            |  |
|                    | FAX                         | 419-523-9441                            |  |
|                    | EMAIL                       | info@technicondesigngroup.com           |  |
|                    | OHIO REGISTRATION<br>NUMBER | OHIO REGISTRATION NO.<br>ARC1917760     |  |
| DESIGNER<br>TYPE   | X ARCHITECT o ENGIN         | NEER O CERTIFIED DESIGNER               |  |
|                    | TYPE OF CONSTRUCTION        | 2B                                      |  |
|                    | CURRENT USE GROUP           | S1/B                                    |  |
|                    | PROPOSED USE GROUP          | S1/B                                    |  |
| DESIGN<br>CRITERIA | BUILDING HEIGHT             | 22'-7" (PARAPET)                        |  |
|                    | NUMBER OF STORIES           | 1                                       |  |
|                    | OCCUPANT LOAD               | NO CHANGE                               |  |
|                    | STORAGE HEIGHT              | N/A                                     |  |
|                    | STORAGE AISLE WIDTH         | N/A                                     |  |
|                    | MIXED USE GROUP             | YES                                     |  |
|                    | SEPARATED                   | NO                                      |  |
|                    | NON-SEPARATED               | YES                                     |  |
|                    | TOTAL BUILDING AREA         | 17,436 S.F.                             |  |
|                    | AREA OF ALTERATION          | 17,436 S.F.                             |  |
|                    | OPEN AREA INCREASE          | N/A                                     |  |
|                    | FIRE SUPPRESSION INCREASE   | NO                                      |  |
|                    | SPECIAL INSPECTIONS         | N/A                                     |  |

|                           | DESIGN LOA   | D DATA       |               |
|---------------------------|--|--------------|---------------|
| GRAVITY<br>LOADS          | FLOOR LIVE UNIFORMLY DI<br>ON GRADE                        | 125 PSF      |               |
|                           | CONCENTRATED (Ibs)   | 2,000 LBS    |               |
|                           | ROOF LIVE  | 20 PSF       |               |
|                           | ROOF DEAD  | 10 PSF       |               |
| SNOW LOADS                | GROUND SNOW LOAD (Pg)                                      | 14 PSF       |               |
|                           | FLAT SNOW LOAD (Pf)  | 20 PSF       |               |
|                           | SNOW EXPOSURE FACTOR                                       | 1.0          |               |
|                           | SNOW LOAD IMPORTANCE                                       | 1.0          |               |
|                           | THERMAL FACTOR (Ct)  | 1.0          |               |
| WIND LOADS                | BASIC WIND SPEED (mph) (Vult/Vasd/Serviceability W. Speed) |              | 115/89/7<br>6 |
|                           | WIND EXPOSURE  |              | В             |
|                           | SEISMIC USE GROUP & IMPORTANCE FACTOR (le)                 |              | II - 1.0      |
|                           | SPECTRAL RESPONSE  | Sds          | 0.128g        |
|                           | COEFFICIENTS   | Sd1          | 0.09g         |
|                           | MAPPED ACCELERATIONS                                       | ss           | 12.00%        |
|                           |  | S1           | 5.6%          |
| EARTHQUAKE<br>DESIGN DATA | SEISMIC DESIGN CATEGOR                                     | В            |               |
|                           | SITE CLASS   | D            |               |
|                           | SEISMIC RESPONSE COEFF                                     | 0.18         |               |
|                           | RESPONSE MODIFICATION F                                    | 7            |               |
|                           | DESIGN BASE SHEAR  | 0.18W        |               |
|                           | ANALYSIS PROCEDURE   | ASCE<br>7-10 |               |
| SPECIAL<br>LOADS          | COLLATERAL ROOF LOAD                                       | N/A          |               |
|                           | LOCATED IN FLOOD-HAZAF                                     | NO           |               |
| SOIL                      | ASSUMED NET ALLOWABLE CAPACITY                             | 1,500 PSF    |               |

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CODE COMPLIANCE PLAN
DESIGN LOAD DATA

ISSUED DATE

02-14-22 OWNER/CONTR REVIEW

02-24-22 FOR BIDS/PERMITS

DRAWN BY: JEM
CHECKED BY: KAN
DATE: 11-21

DATE:
PLOT SCALE:

JOB NO. 74-2724-21 SHEET

> G101 1 SHEETS

### DEMOLITION KEYNOTE LEGEND (A) REMOVE EXISTING DOOR, FRAME AND HARDWARE. (B) REMOVE EXISTING WINDOW AND FRAME. (C) REMOVE EXISTING BRICK MASONRY.

- (D) REMOVE EXISTING CMU ABOVE EXISTING CONCRETE WALL. (E) REMOVE EXISTING METAL WALL PANELS AND TRIMS.  $\langle F \rangle$ REMOVE EXISTING SIGNAGE ON BUILDING.
- © REMOVE EXISTING CONCRETE FLOOR. H REMOVE EXISTING CATCH BASIN- SEE PLUMBING DRAWINGS.
- | REMOVE EXISTING OIL INTERCEPTOR AND VENTING- SEE PLUMBING DRAWNGS.
- CUT AND REMOVE EXISTING WALL AS REQUIRED FOR NEW DOOR OPENING. K REMOVE EXISTING FLOOR DRAIN- SEE PLUMBING DRAWINGS

- (L) REMOVE EXISTING OVERHEAD DOOR, TRACK AND OPENER
- (M) EXISTING UNDER SLAB PIT TO BE REMOVED
- (N) REMOVE EXISTING DOWNSPOUT
- (0) REMOVE EXISTING 12" (4'-0" HIGH) CONCRETE WALL DOWN TO 8" BELOW EXISTING CONCRETE FLOOR. SEE DETAIL 9/A501
- (P) REMOVE EXISTING DRINKING FOUNTAIN- SEE PLUMBING **DRAWINGS**
- REMOVE AND SALVAGE EXISTING TWO COMPARTMENT UTILITY SINK- SEE PLUMBING DRAWINGS.
- REMOVE EXISTING WALL FAUCET- SEE PLUMBING

### GENERAL DEMOLITION NOTES 1. ALL CONTRACTORS SHALL BE RESPONSIBLE FOR THE PROTECTION OF SURROUNDING ADJACENT OR ATTACHED COMPONENTS & MATERIALS 2. ALL CONTRACTORS SHALL FIELD VERIFY ALL

DURING DEMOLITION.

BEGINNING WORK.

PANELS.

EXIST. MASTIC.

STRUCTURE.

EXISTING CONDITIONS & UTILITY LOCATIONS

RESOLUTION FROM ARCHITECT PRIOR TO

3. THE OWNER SHALL RETAIN RIGHTS OF OWNERSHIP FOR ALL SALVAGED MATERIALS &

AND PROPERLY DISPOSED OF BY THE CONTRACTOR.

EQUIPMENT REMOVED. SALVAGED ITEMS SHALL

DIRECTED BY THE OWNER. NON-SALVAGEABLE

4. WHERE EXISTING WALLS, CEILINGS, FLOORS, ETC. TO REMAIN ARE DAMAGED DURING DEMOLITION &

REPAIR EXISTING DAMAGED SURFACES TO MATCH EXISTING ADJACENT SURFACE MATERIALS, INCLUDING LOCATIONS WHERE PLUMBING,

MECHANICAL & ELECTRICAL ARE REMOVED. SEE

PLMG., MECH. & ELEC. DWGS. FOR LOCATIONS.

CONSTRUCTION, THE G.C. SHALL PATCH &

5. FIELD VERIFY LOCATIONS OF EXISTING ELEC.

CEILINGS, FLOORS & OTHER STRUCTURAL

MEMBERS DURING DEMOLITION. SHORING SHALL BE LEFT IN PLACE UNTIL NEW WORK IS IN

FLOORS AS REQ'D. FOR INSTALLATION OF NEW

UNDER SLAB UTILITIES SHALL BE BY THE G.C., U.N.O., ALL TRENCHING & BACKFILL SHALL BE BY THE P.C., M.C. OR E.C. RESPECTIVELY THE G.C. SHALL PATCH & REPAIR ALL CONCRETE, COORDINATE WORK BETWEEN TRADES, SEE

6. THE G.C. SHALL PROVIDE ALL NECESSARY SHORING REQ'D. FOR SUPPORT OF WALLS,

7. SAW CUTTING & REMOVAL OF CONCRETE

DEMOLITION & PLUMBING DRAWINGS

8. REMOVAL OF FLOOR COVERINGS, SUBSTRATES

(IF ANY), ETC. SHALL BE TO THE EXIST. CONCRETE FLOOR, INCLUDING THE REMOVAL OF


9. THE OWNER IS RESPONSIBLE FOR THE REMOVAL OF ALL SHELVING, TOOLS, EQUIPMENT ETC THAT ARE NOT CONNECTED TO THE BUILDING

MATERIALS SHALL BE REMOVED FROM THE SITE

BE RELOCATED OR PLACED IN STORAGE AS

PRIOR TO BIDDING & BEGINNING WORK. IN THE

EVENT OF CONFLICTS, CONTRACTOR SHALL SEEK

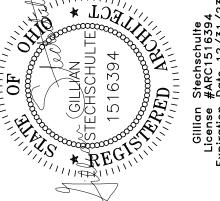

2 **□** # g chnic 15

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DEMOLITION FLOOR PLAN


ISSUED DATE 12-22-21 OWNER REVIEW
02-07-22 OWNER REVIEW
02-14-22 OWNER/CONTR REVIEW
02-24-22 FOR BIDS/PERMITS


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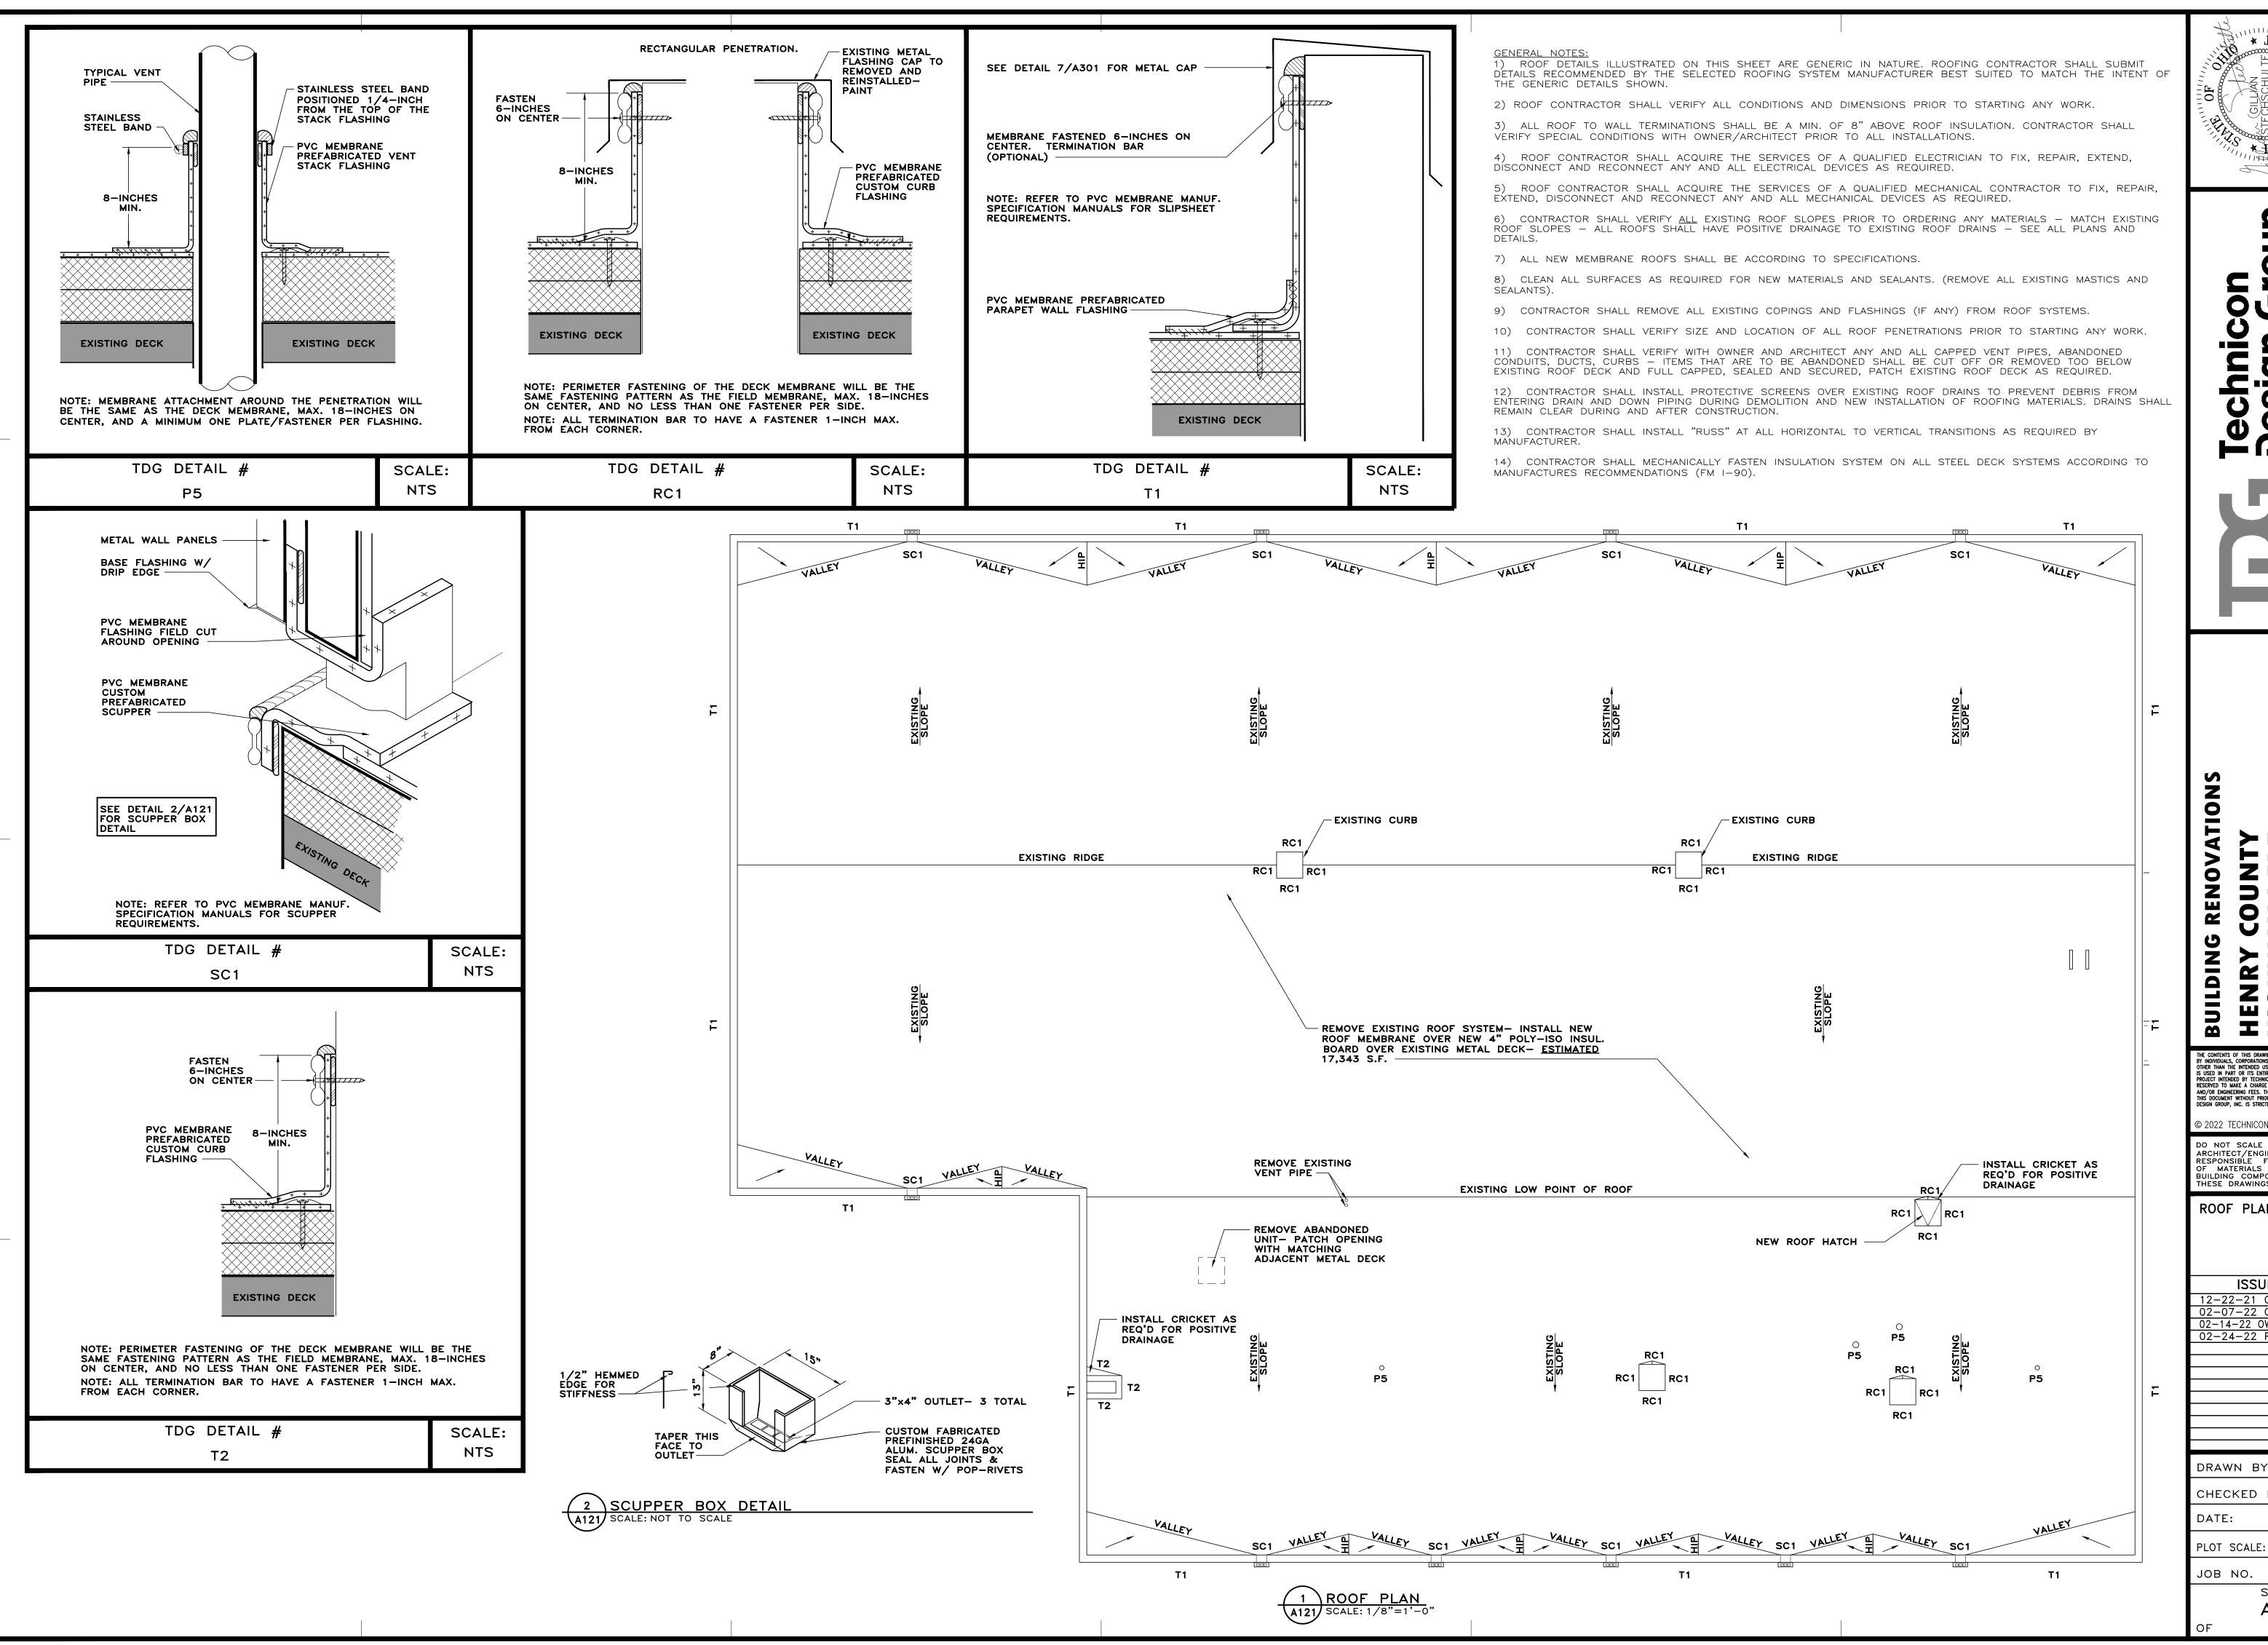
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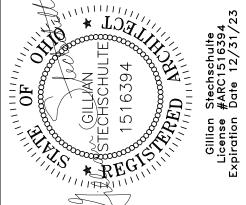
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> D101 1 SHEETS







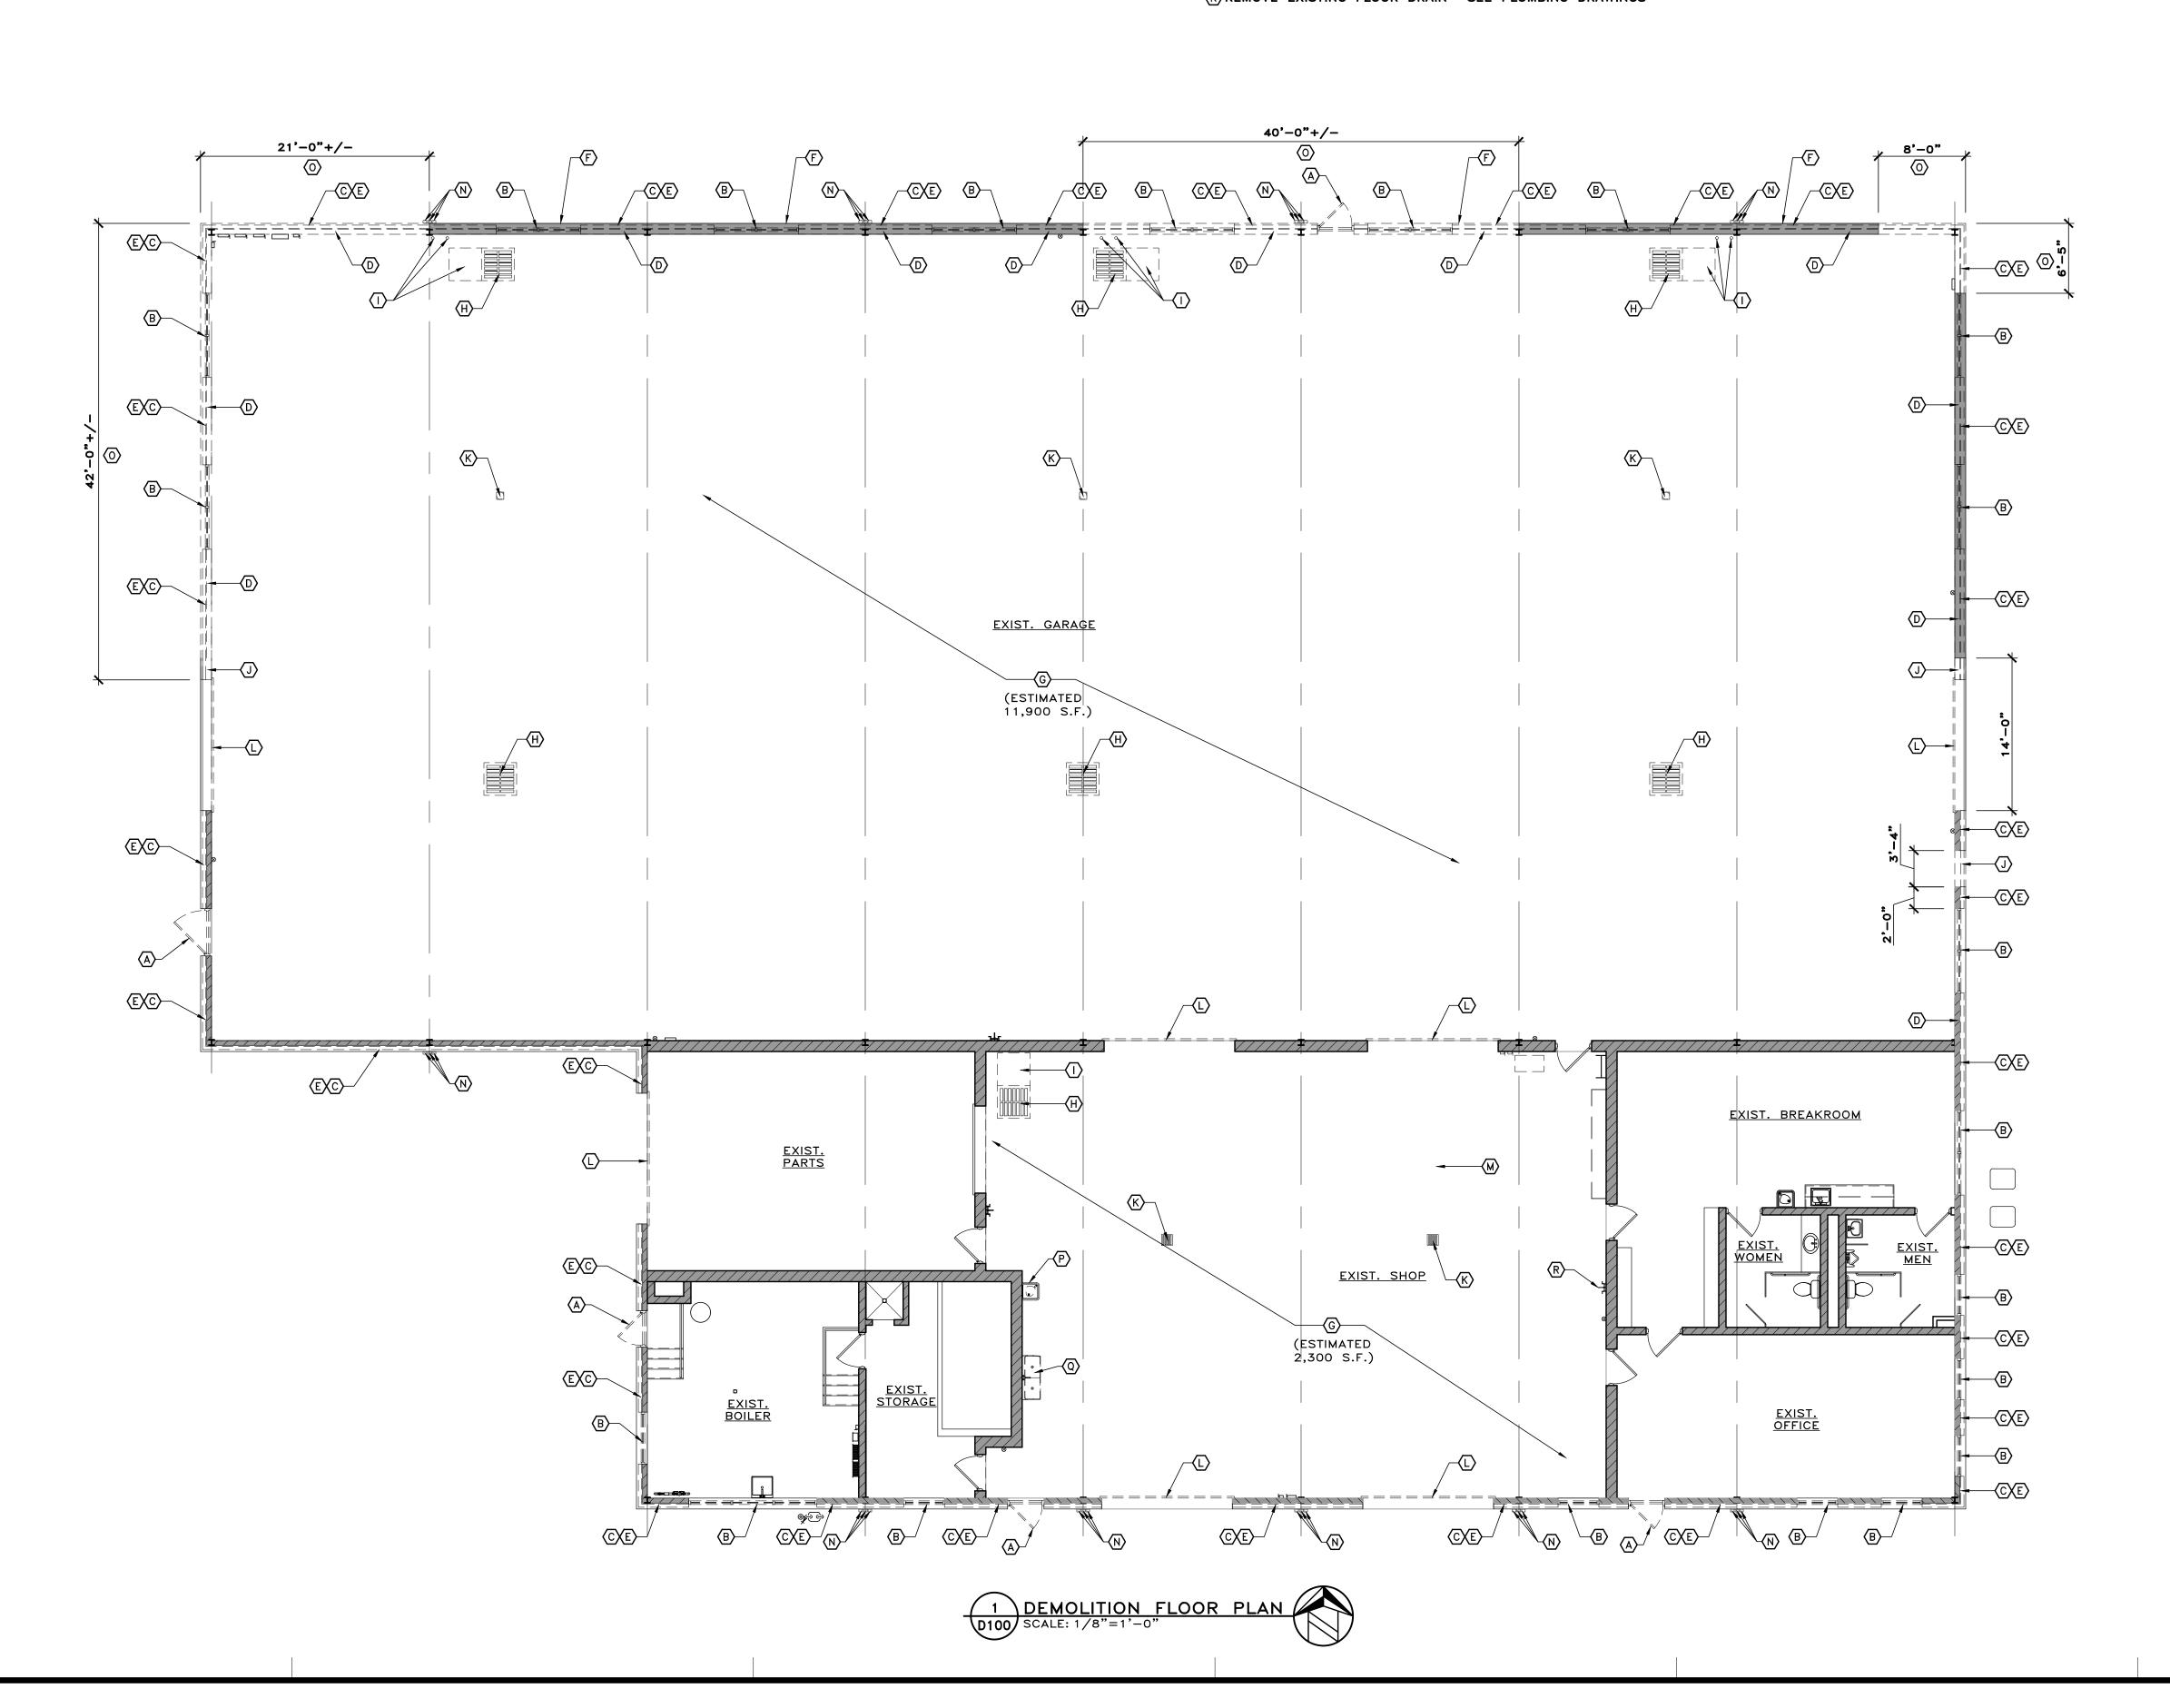
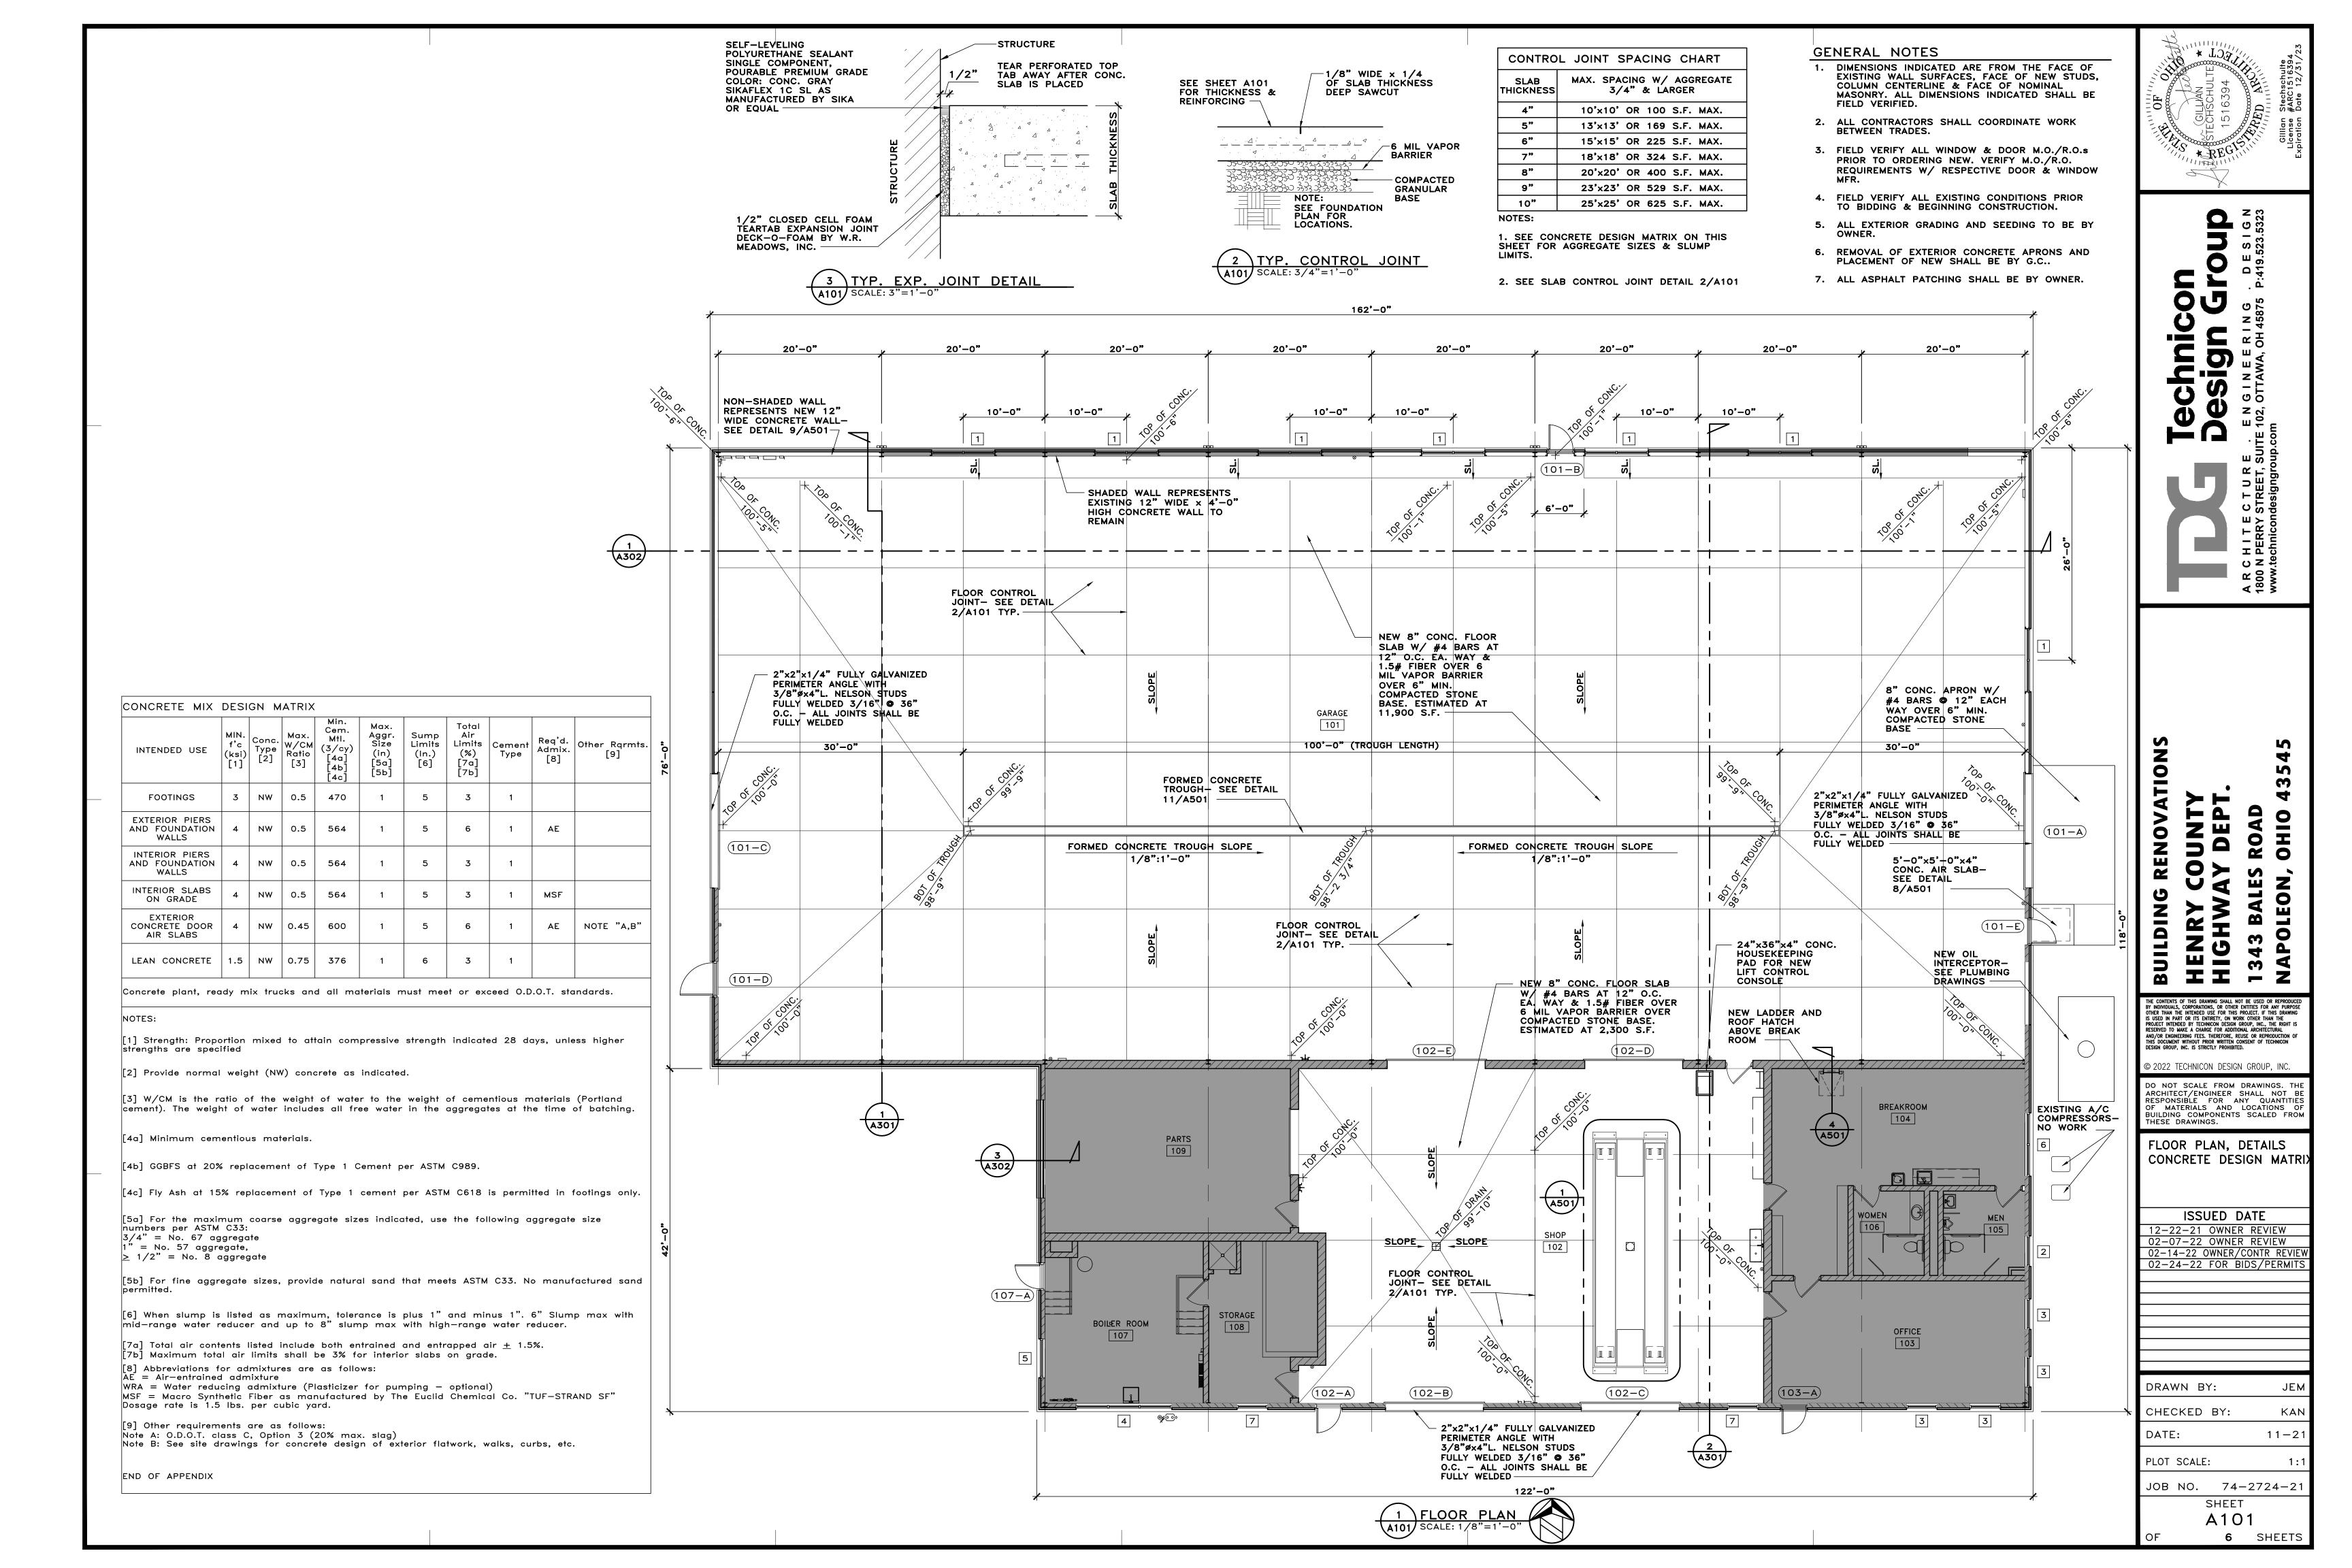
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SINEERING DESIGN
TTAWA, OH 45875 P:419.523.5323

ARCHITECTURE . ENGI

HENRY COUNTY
HIGHWAY DEPT.

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ROOF PLAN AND DETAILS

ISSUED DATE

12-22-21 OWNER REVIEW

02-07-22 OWNER REVEIW


02-14-22 OWNER/CONT. REVIEW


02-24-22 FOR BIDS/PERMITS


DRAWN BY: JEM
CHECKED BY: KAN
DATE: 11-21


JOB NO. 74-2724-21
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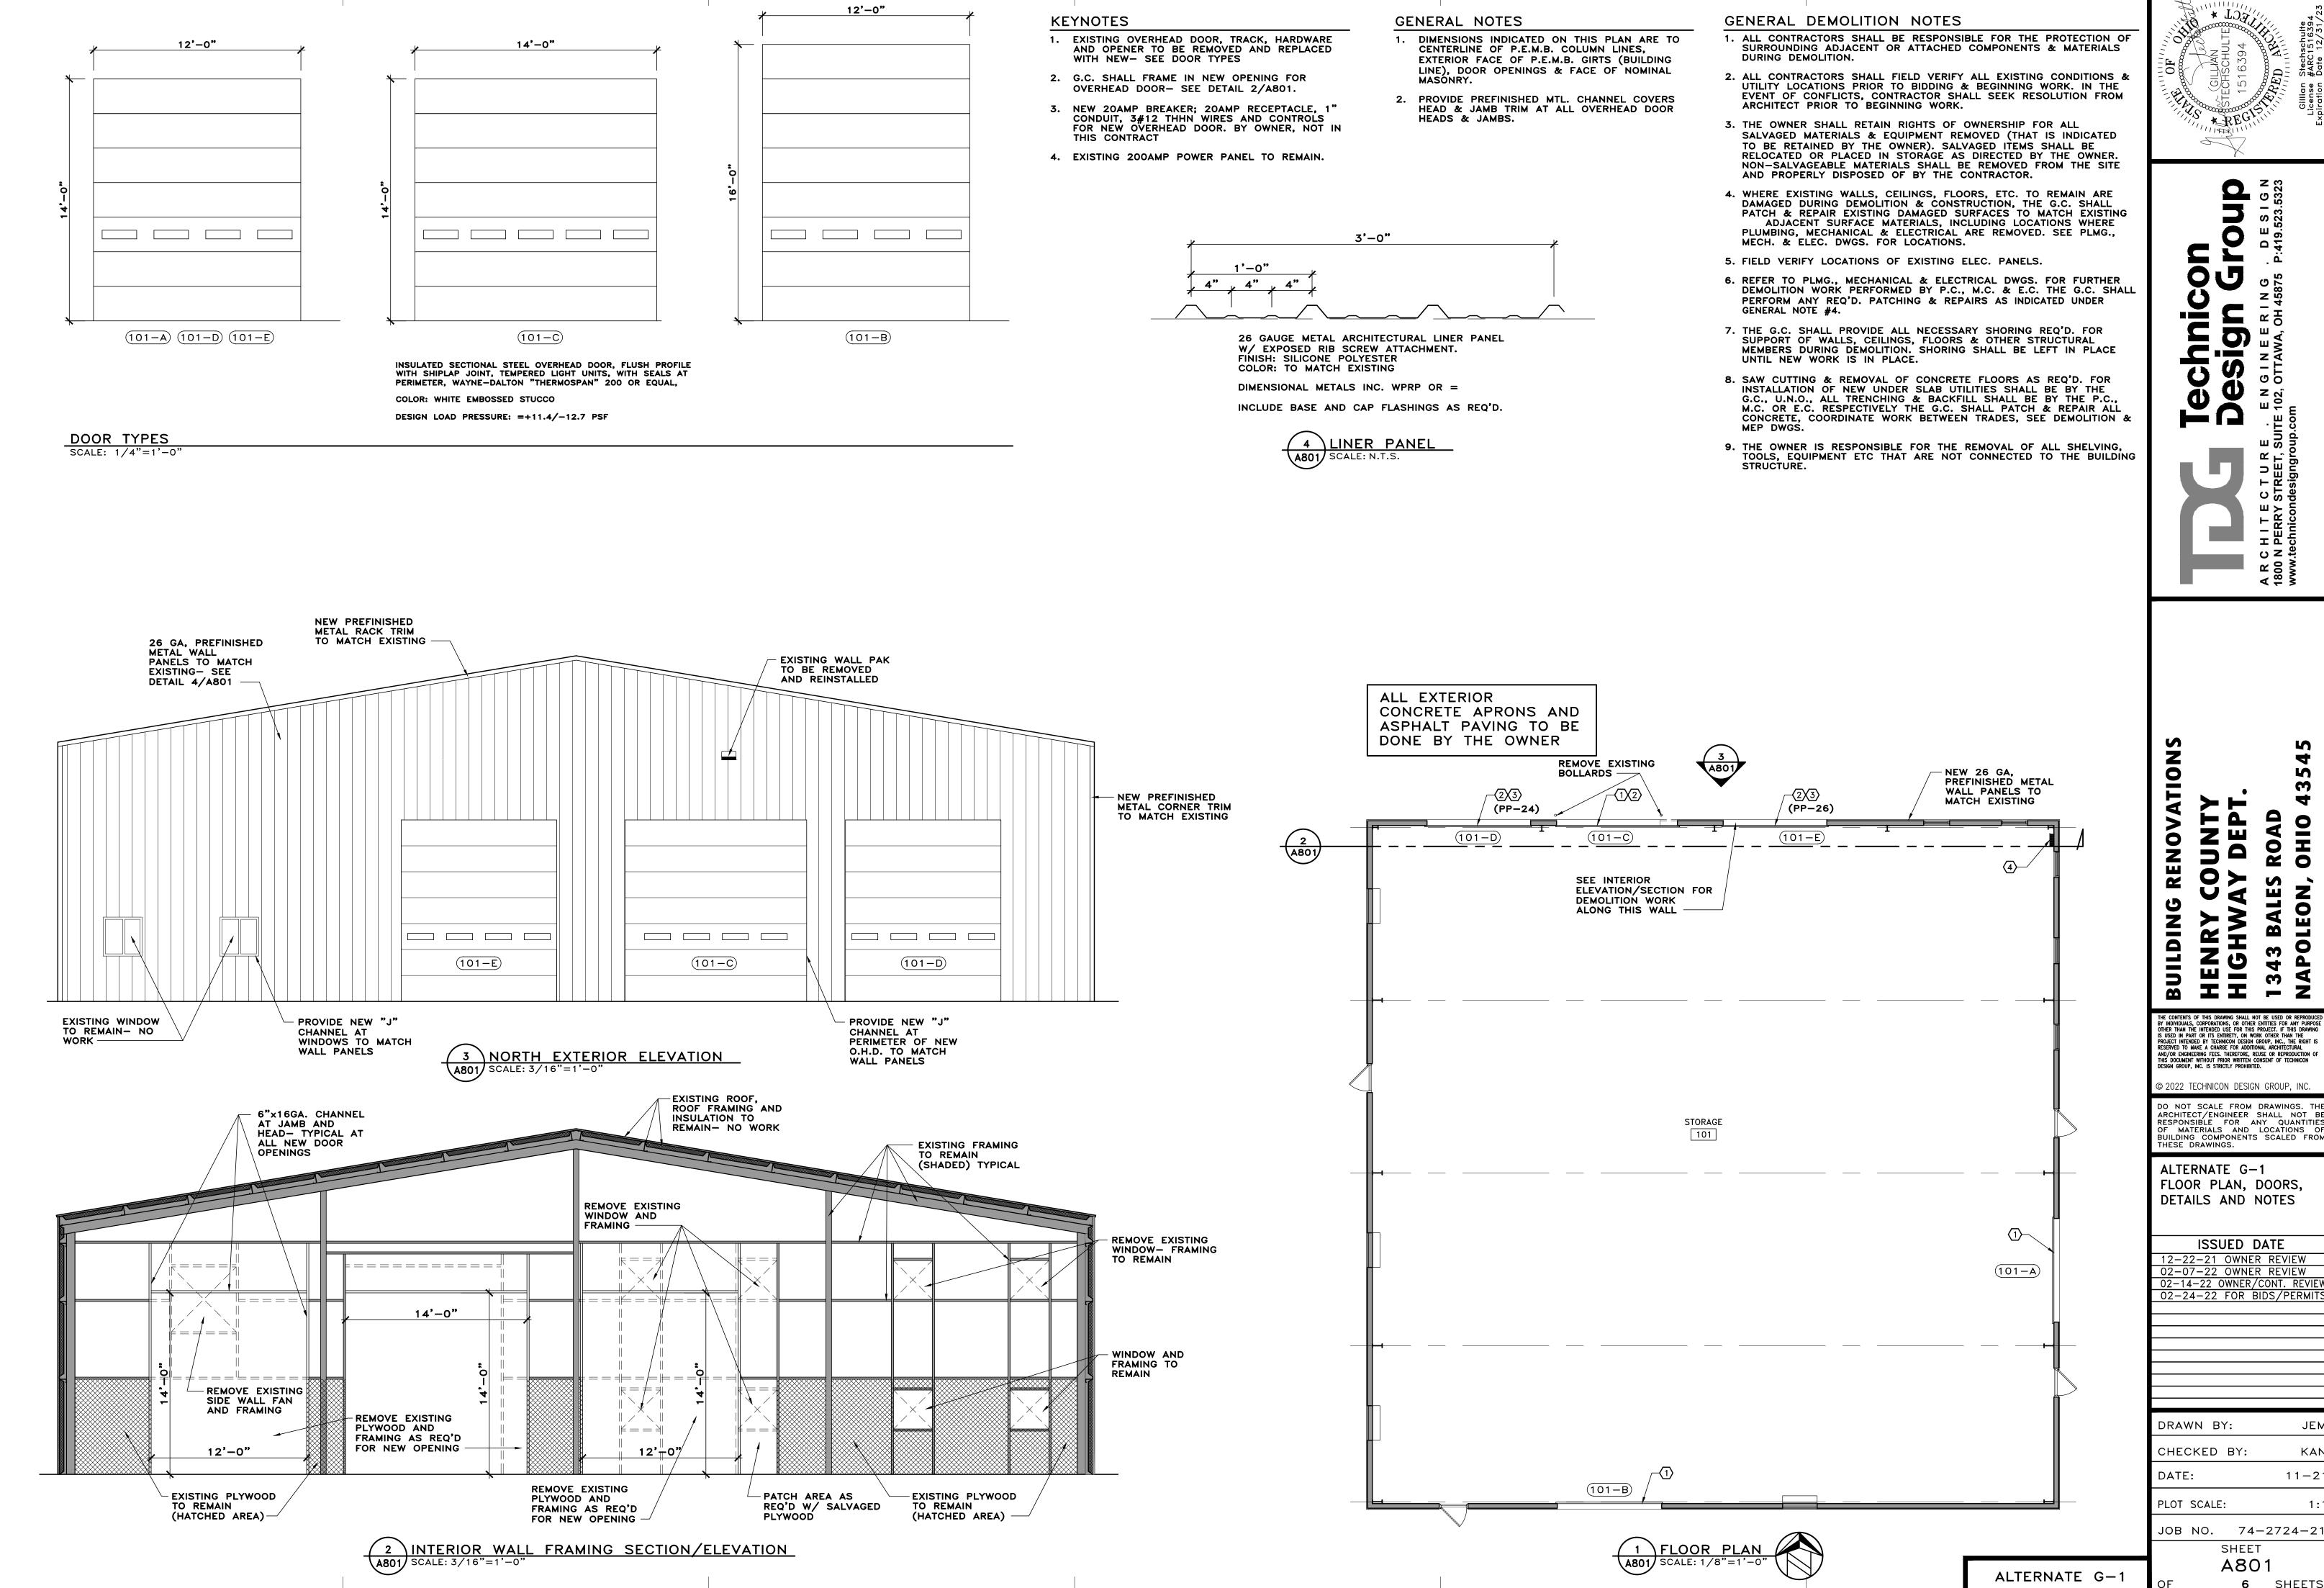




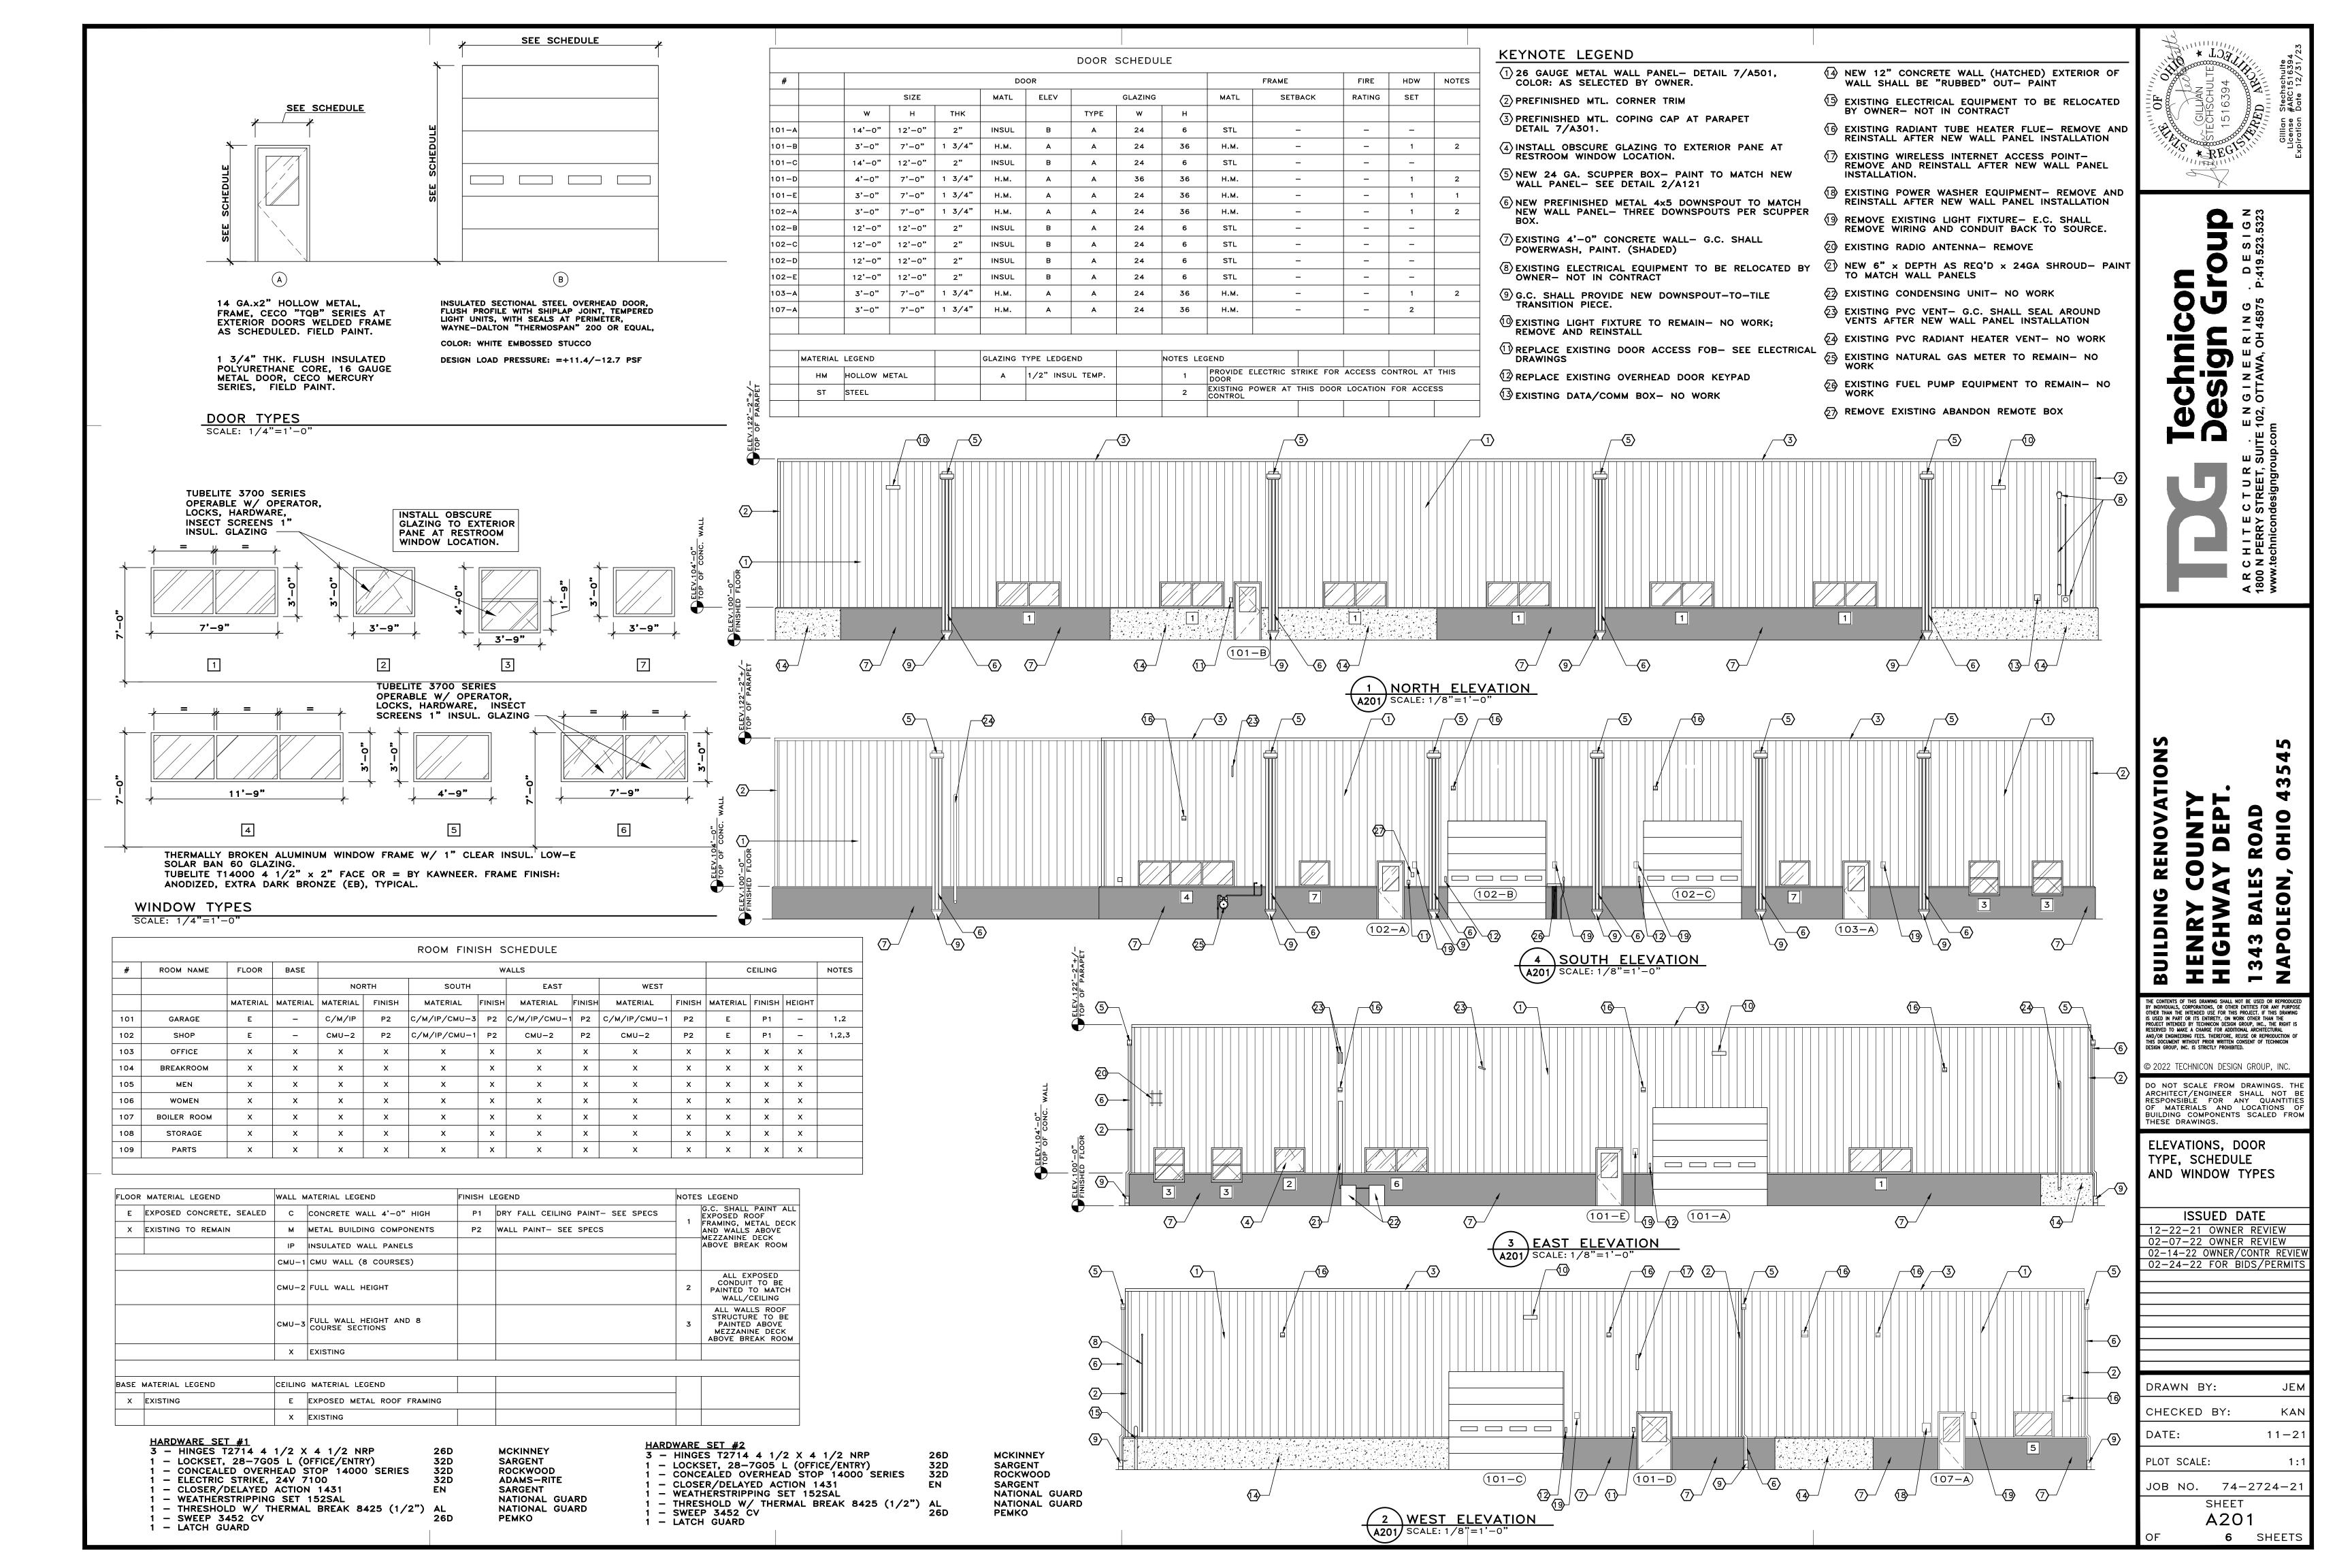

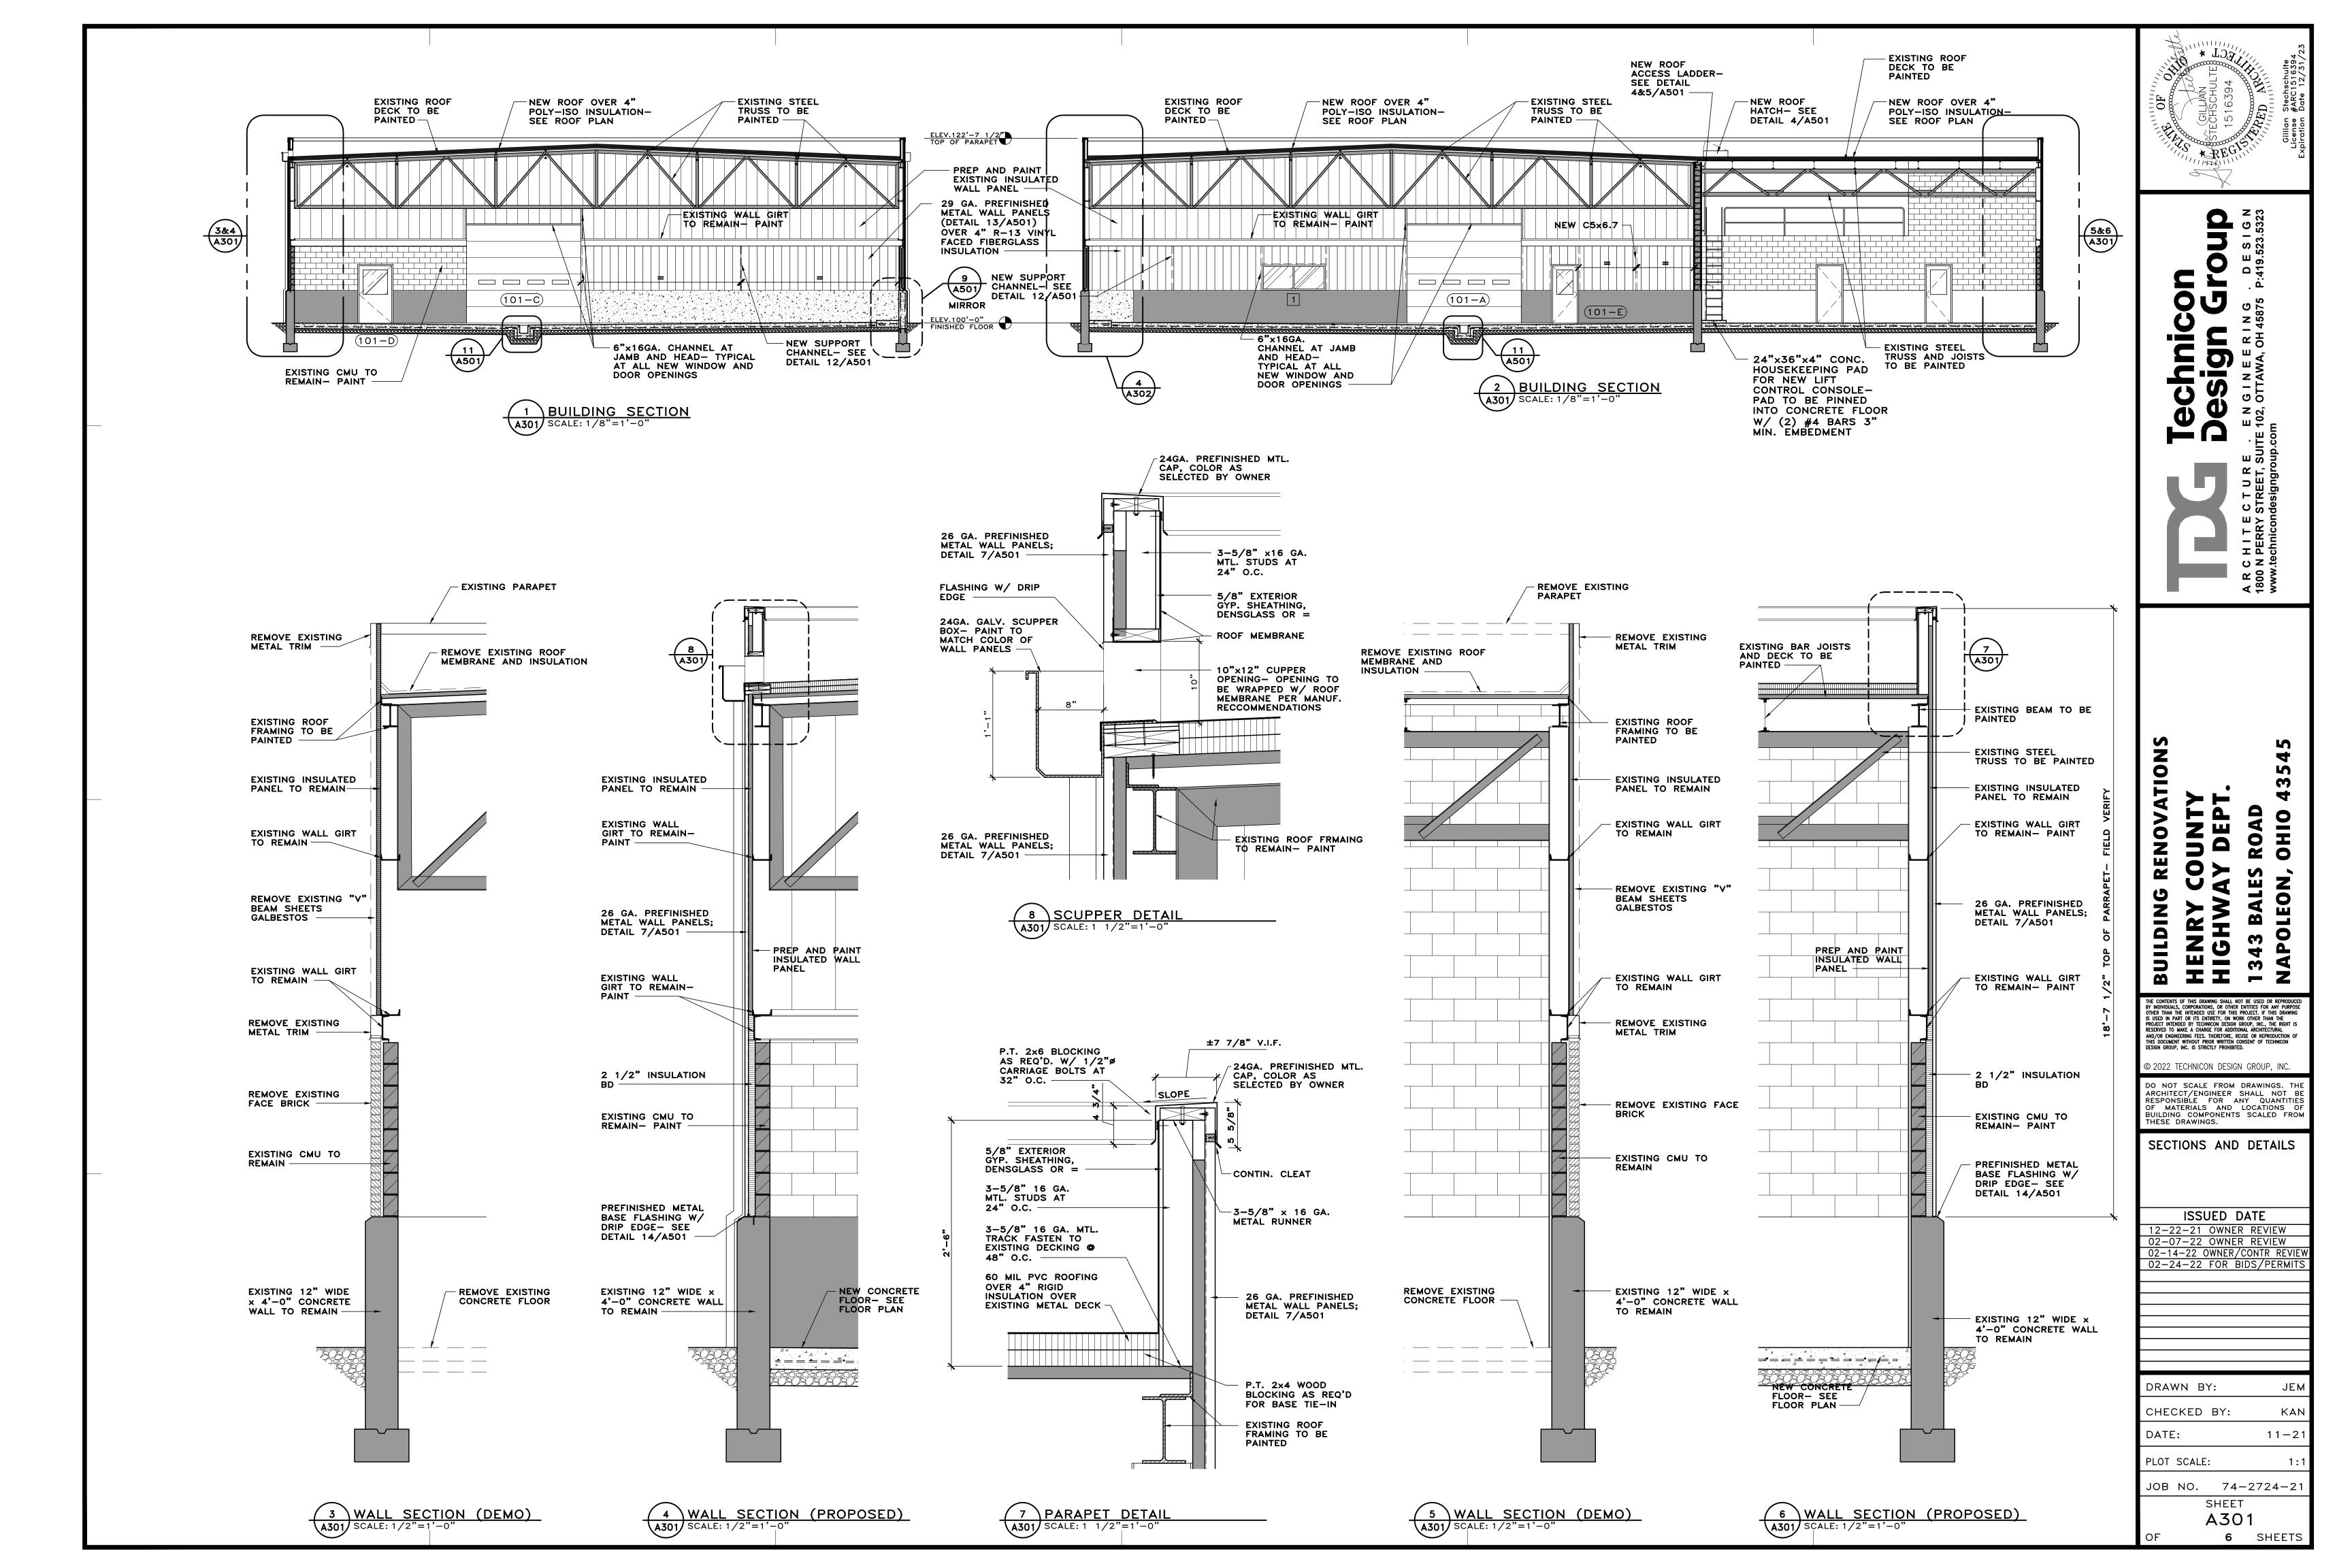
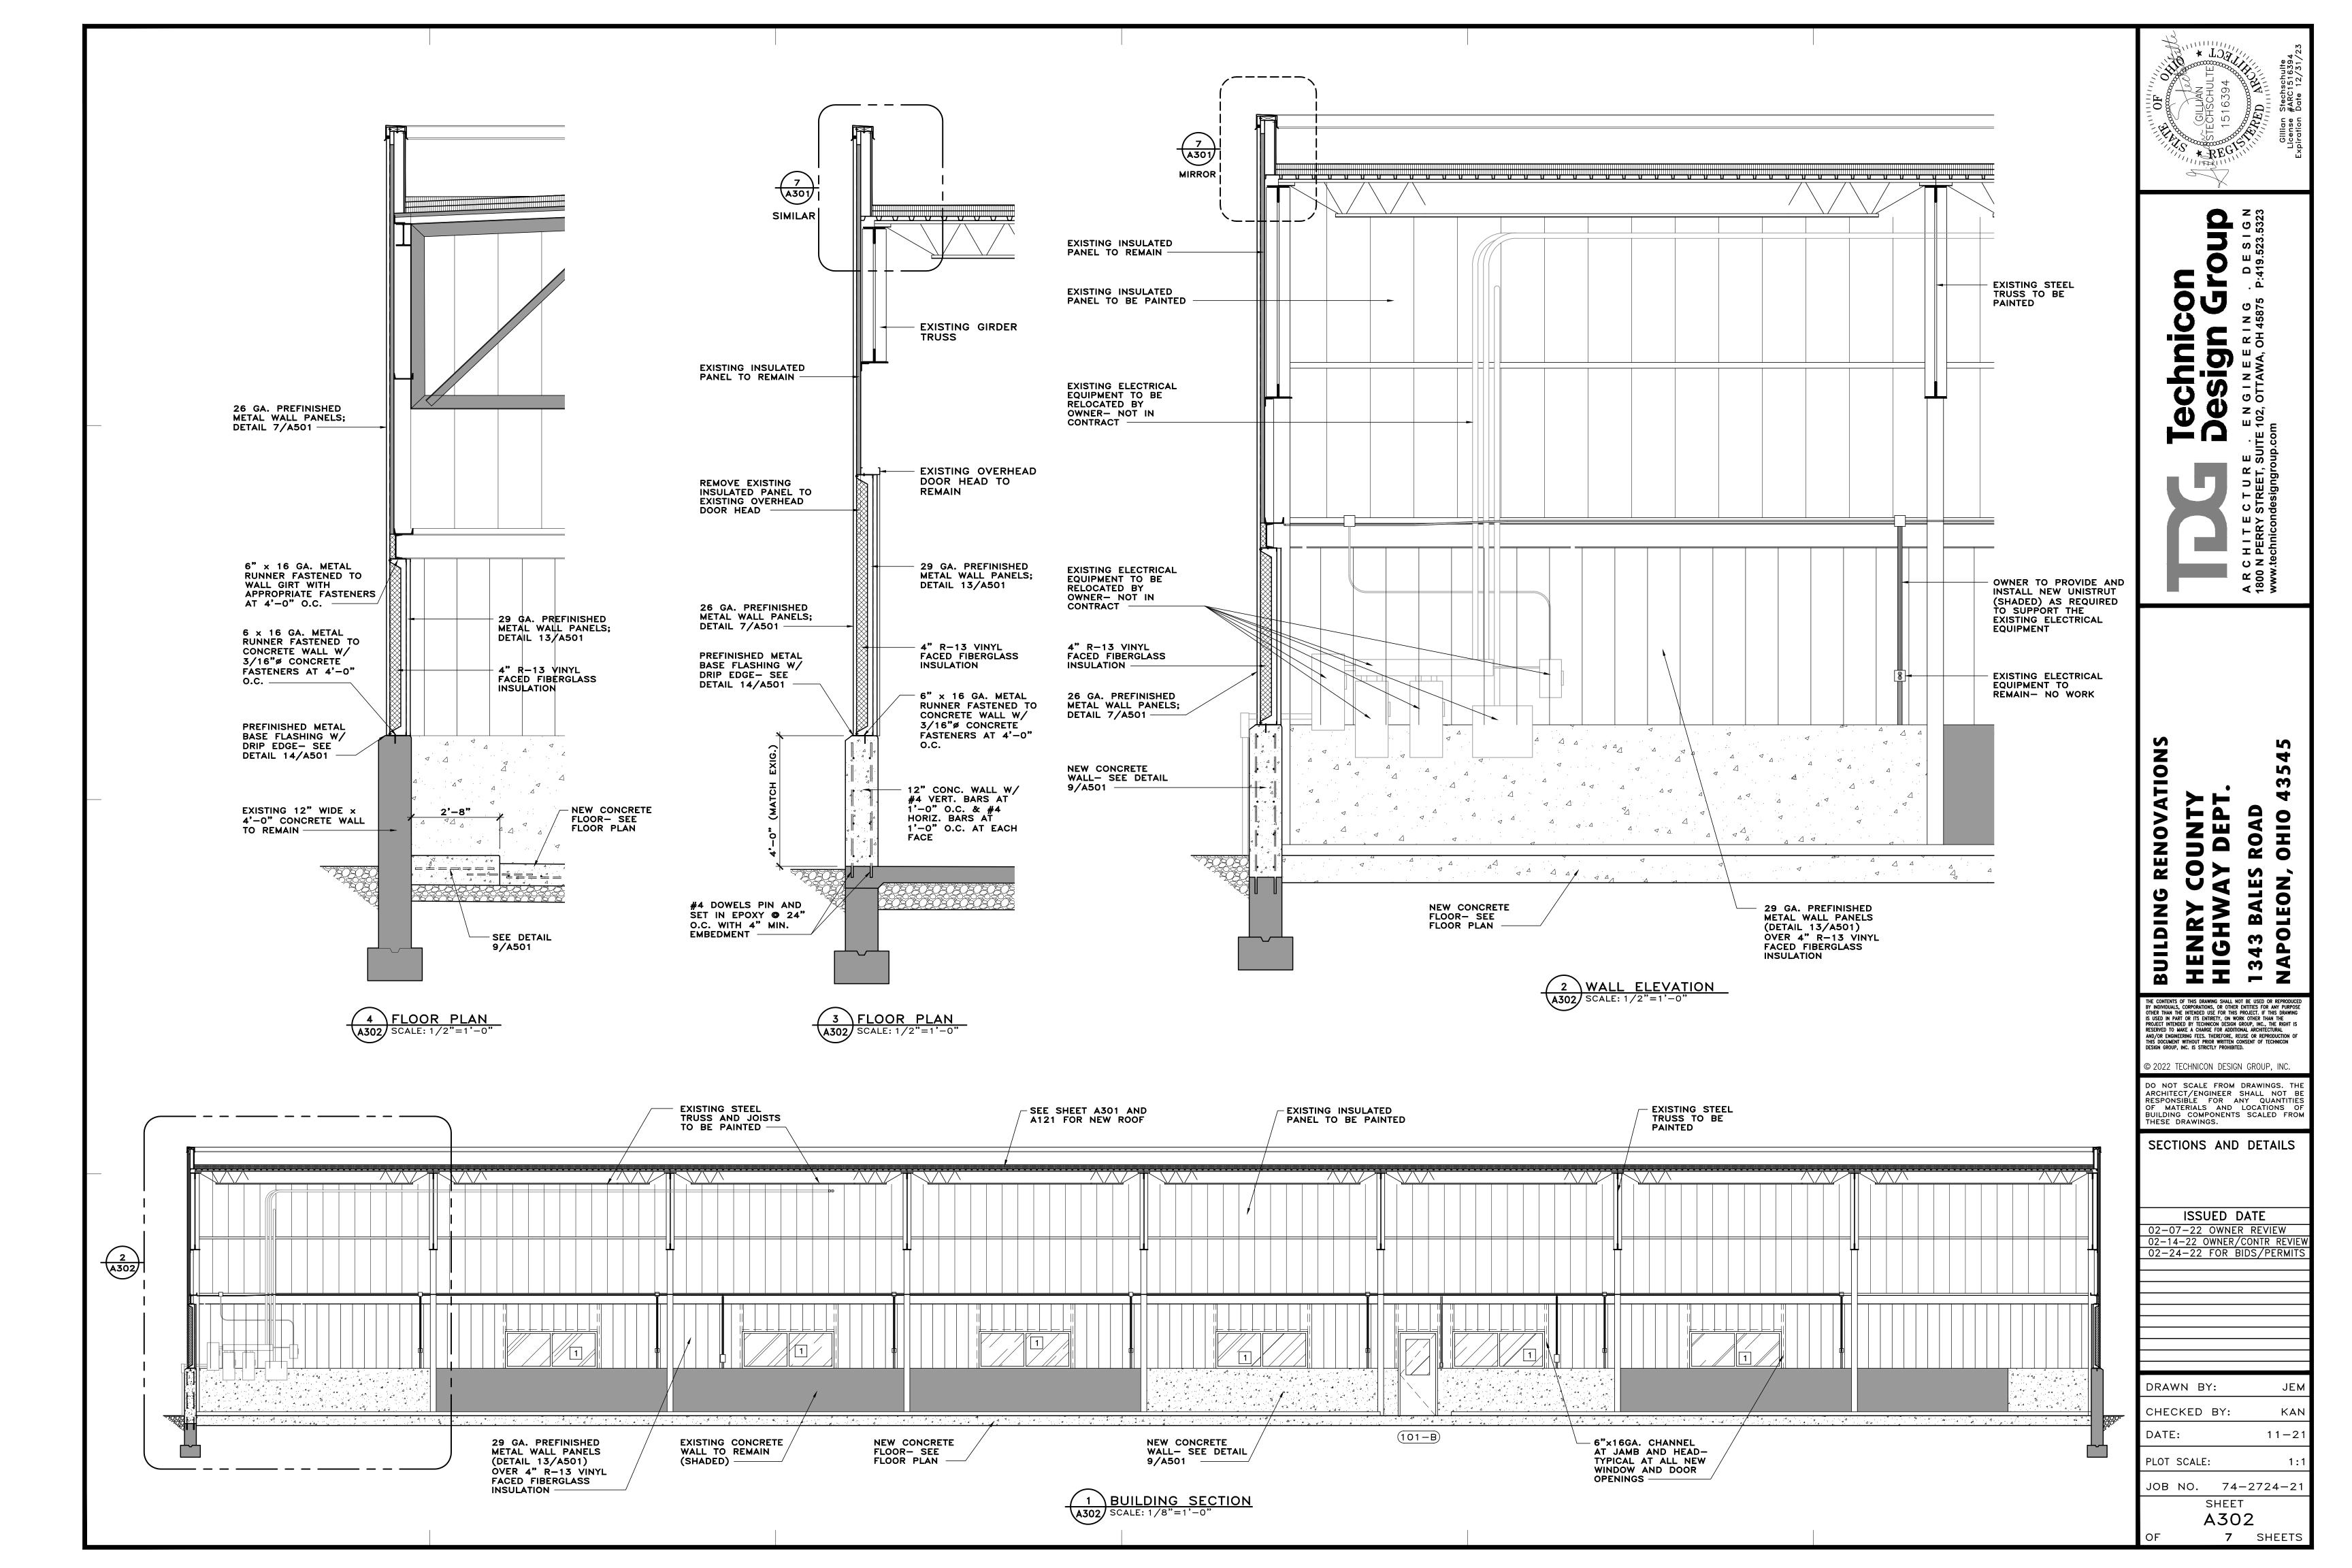
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ALTERNATE G-1 FLOOR PLAN, DOORS, DETAILS AND NOTES

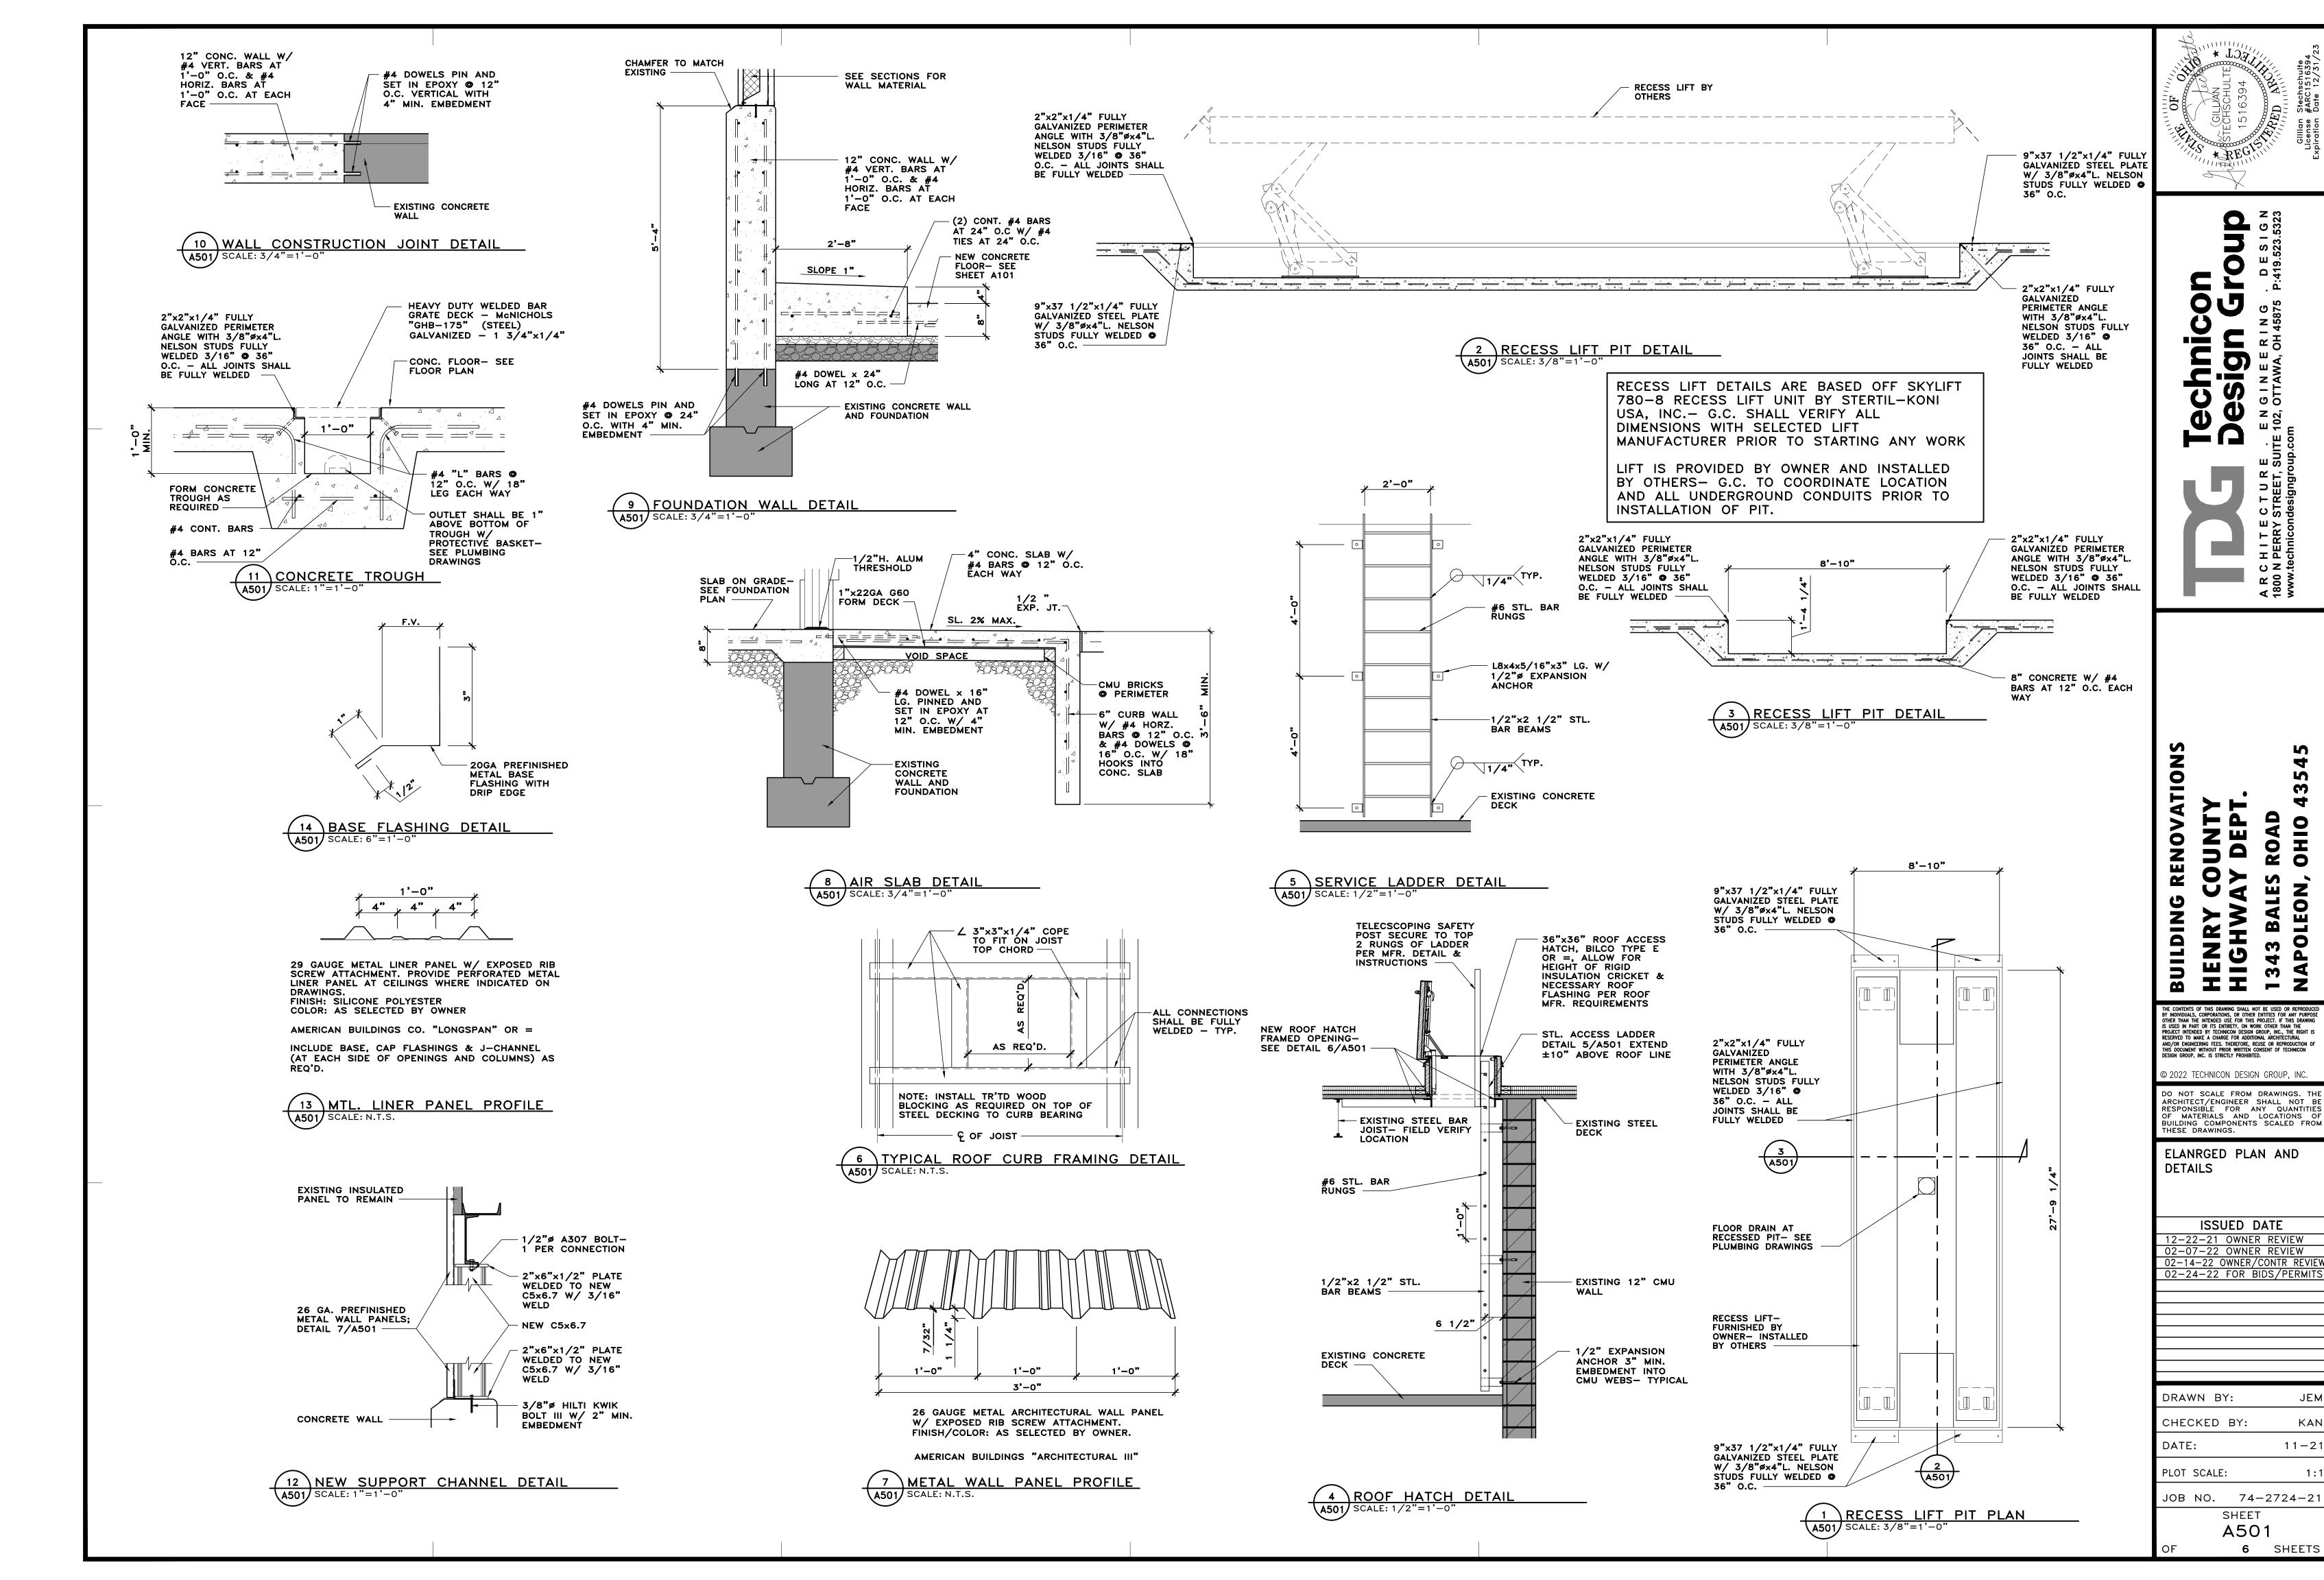ISSUED DATE 12-22-21 OWNER REVIEW
02-07-22 OWNER REVIEW
02-14-22 OWNER/CONT. REVIEW 02-24-22 FOR BIDS/PERMITS

DRAWN BY: CHECKED BY:

DATE: 11 - 21PLOT SCALE:


JOB NO. 74-2724-21 SHEET


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6 SHEETS

#### GENERAL DEMOLITION NOTES

- ALL CONTRACTORS SHALL FIELD VERIFY ALL EXISTING CONDITIONS AND UTILITY LOCATIONS PRIOR TO BIDDING & BEGINNING WORK. IN THE EVENT OF CONFLICTS, CONTRACTOR SHALL SEEK RESOLUTION FROM OWNER AND/OR ARCHITECT PRIOR TO BEGINNING WORK.
- 2. THE OWNER SHALL RETAIN RIGHTS OF OWNERSHIP FOR ALL SALVAGEABLE MATERIALS, FIXTURES, AND EQUIPMENT REMOVED. SALVAGED ITEMS SHALL BE RELOCATED OR PLACED IN STORAGE AS DIRECTED BY OWNER. NON—SALVAGEABLE MATERIALS OR ITEMS THEY DO NOT WANT SHALL BE REMOVED FROM THE SITE AND PROPERLY DISPOSED OF BY THE CONTRACTOR.
- 3. ANY PLUMBING FIXTURES BEING REMOVED AND SALVAGED FOR REUSE
  (SEE KEYNOTES) SHALL BE PROPERLY STORED AND PROTECTED FROM DAMAGE UNTIL FIXTURES ARE
  READY FOR INSTALLATION. FIXTURES SHALL BE THOROUGHLY CLEANED AFTER INSTALLATION.
- 4. THE LOCATIONS AND SIZES OF EXISTING UNDER SLAB SANITARY LINES MUST BE FIELD VERIFIED PRIOR TO ANY SAW CUTTING OF FLOOR SLABS.
- P.C. SHALL FIELD VERIFY ALL EXISTING CONDITIONS AND TRACE EXISTING SUPPLY PIPING MAINS, BRANCHES AND FEEDS TO ALL EXISTING LOCATIONS AND FIXTURES PRIOR TO SHUTTING OFF WATER AND REMOVING EXISTING PIPING.



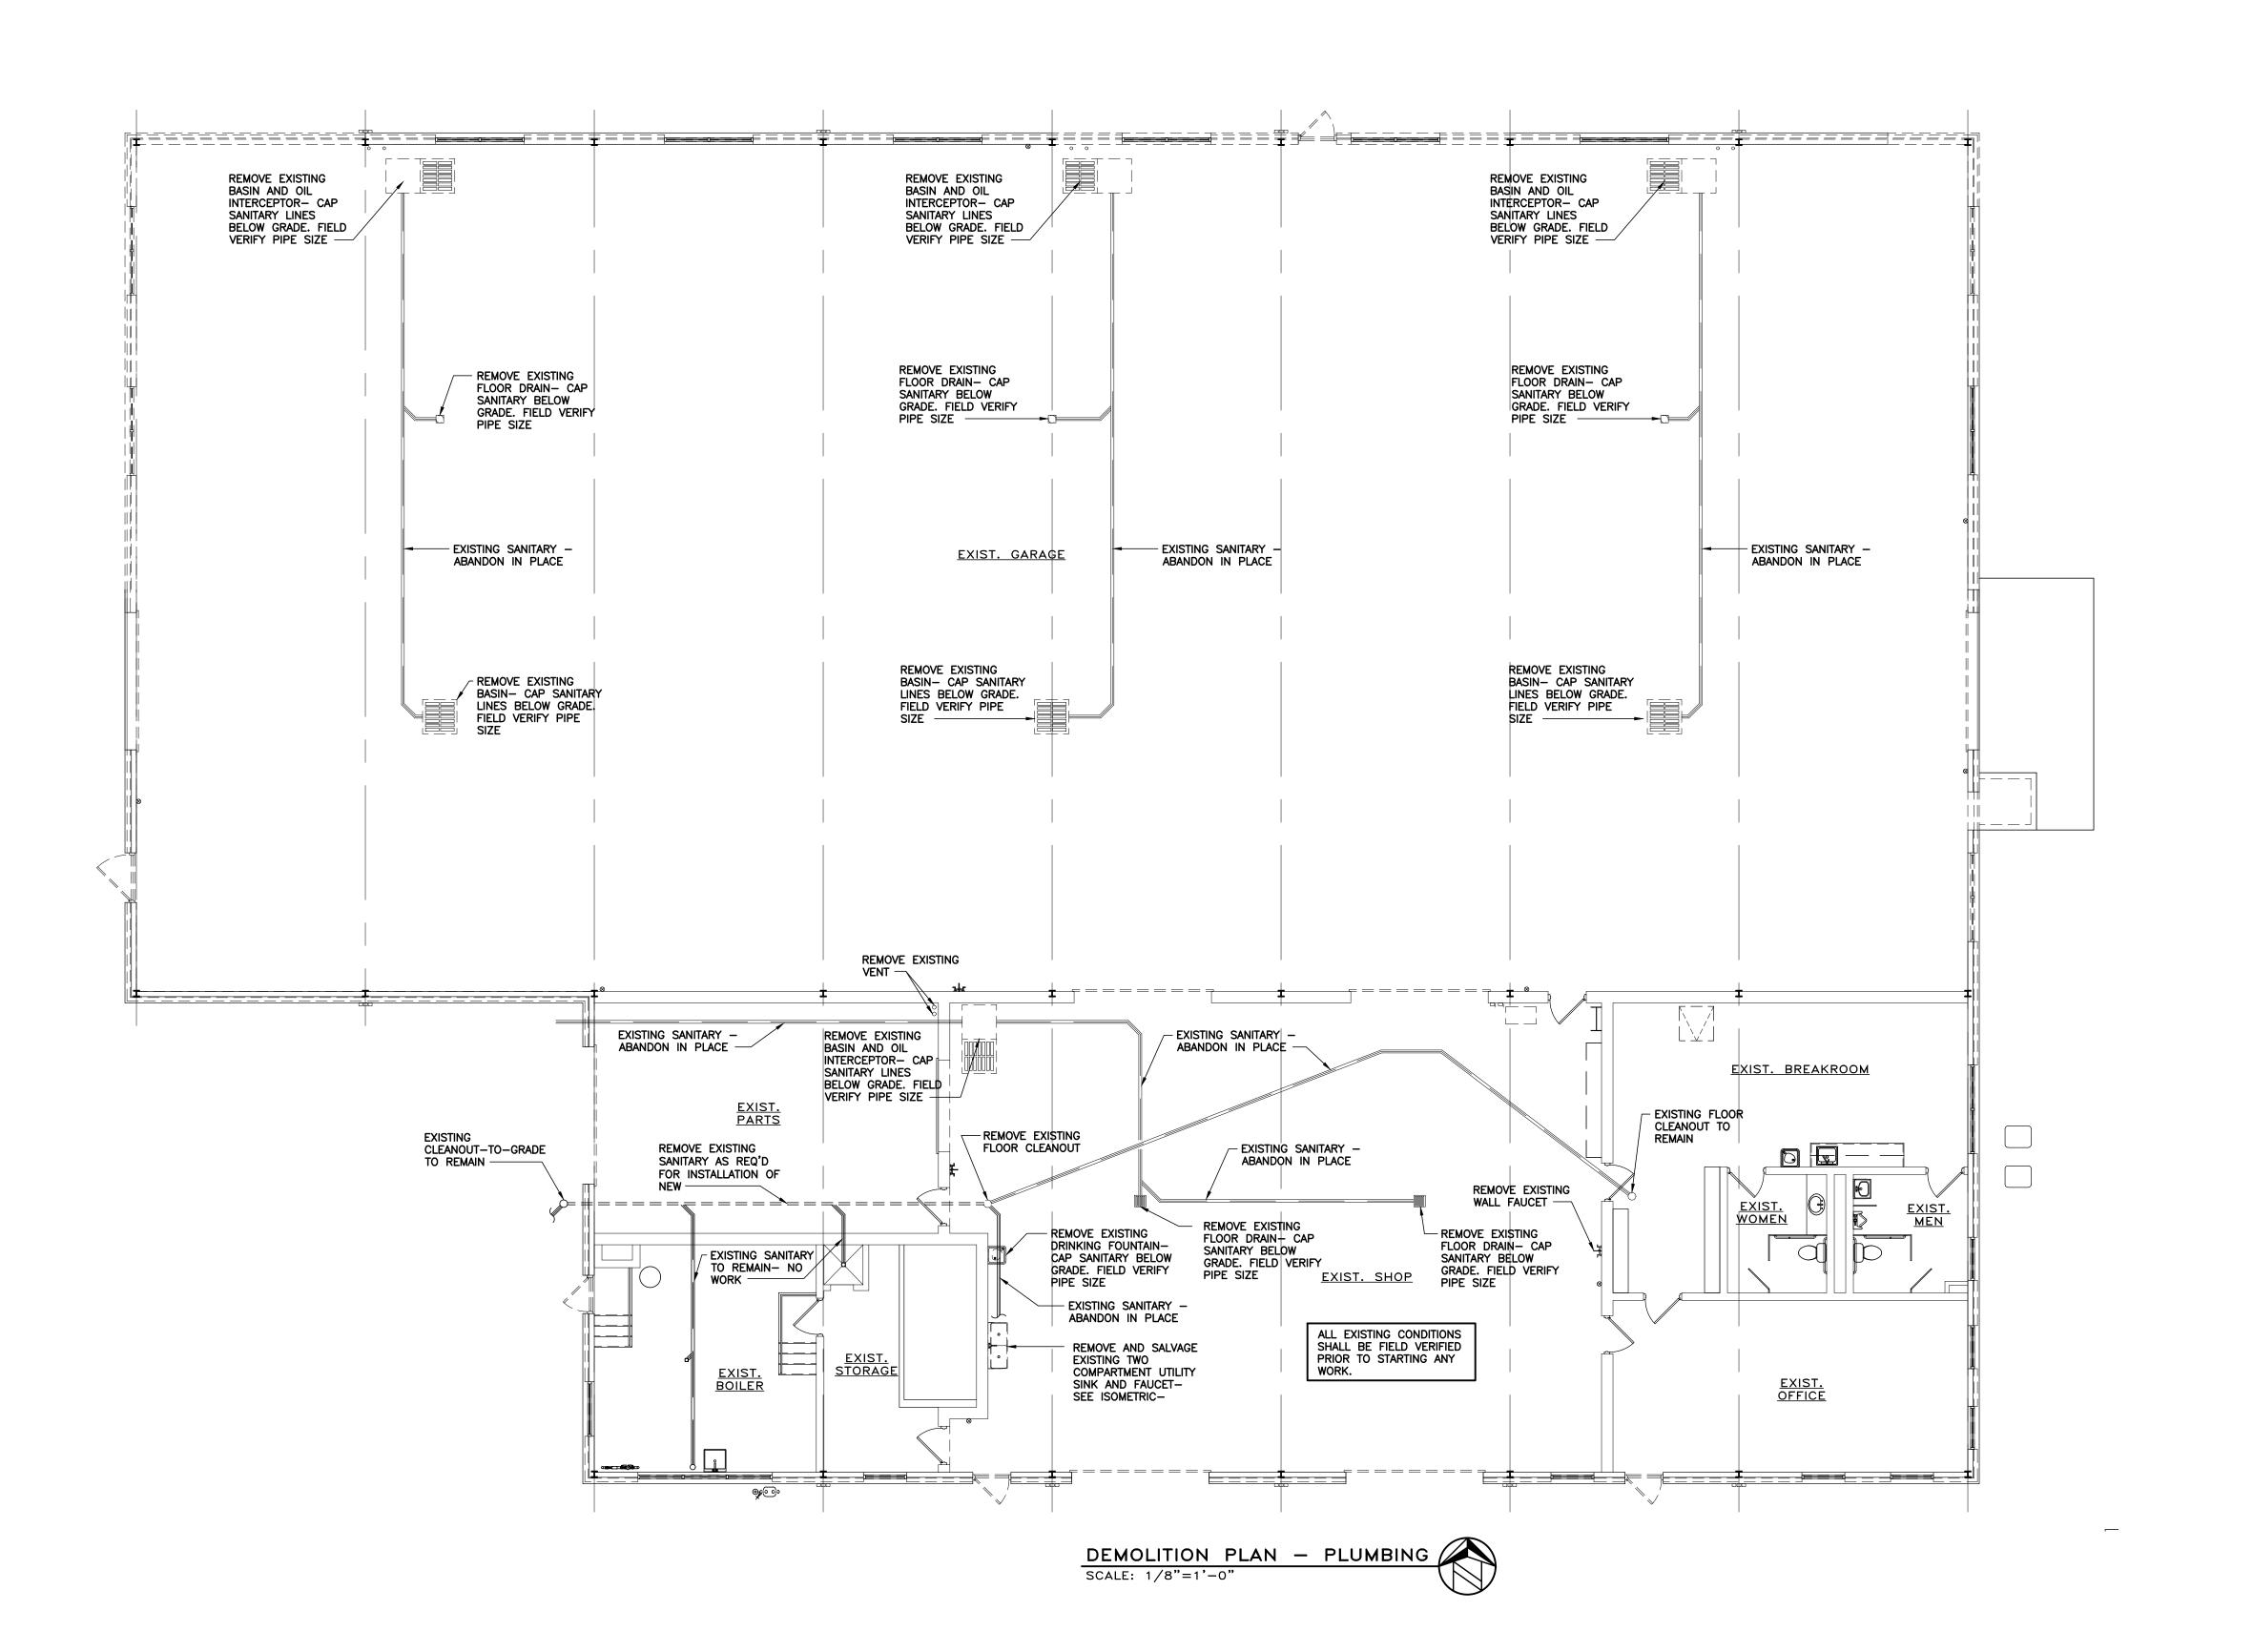

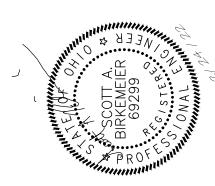Technicon

HITECTURE . ENGINEERING . DESIGN

PERRY STREET, SUITE 102, OTTAWA, OH 45875 P:419.523.5323

BUILDING RENOVATIONS

HENRY COUNTY
HIGHWAY DEPT.

1343 BALES ROAD
NAPOLEON, OHIO 43545

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DEMO PLUMBING PLAN AND NOTES

ISSUED DATE

02-07-22 OWNER REVIEW

02-14-22 OWNER/CONTR REVIEW

02-24-22 FOR BIDS/PERMITS

DRAWN BY: JEM
CHECKED BY: SAB
DATE: 11-21
PLOT SCALE: 1:1

JOB NO. 74-2724-21
SHEET
P100

P100 4 SHEETS

| PLUMBING CONTRACTOR                          | P.C.   |  |
|--|--------|--|
| GENERAL CONTRACTOR                           | G.C.   |  |
| MECHANICAL CONTRACTOR                        | M.C.   |  |
| ELECTRICAL CONTRACTOR                        | E.C.   |  |
| AUTHORITY HAVING JURISDICTION                | A.H.J. |  |
| ABOVE FINISHED FLOOR                         | A.F.F. |  |
| SOIL , WASTE OR SANITARY SEWER - ABOVE FLOOR | SAN    |  |
| SOIL , WASTE OR SANITARY SEWER - BELOW FLOOR | SAN    | ======================================   |
| /ENT   | V      |  |
| DOMESTIC COLD WATER                          | DCW    |  |
| DOMESTIC HOT WATER                           | DHW    |  |
| NATURAL GAS                                  | NG     | NG   |
| NATER HAMMER ARRESTER                        | WHA    | $\otimes$  |
| PLUMBING DRAINAGE INSTITUTE 'SIZE'           | PDI    |  |
| VENT THRU ROOF                               | VTR    |  |
| FLOOR CLEANOUT                               | FCO    |  |
| CLEANOUT TO GRADE                            | COTG   |  |
| SHUTOFF VALVE                                |        | $\longrightarrow \!$ |

#### 

- INSTALL 4" FLOOR CLEANOUT. SEE FLOOR CLEANOUT DETAIL '2' ON SHEET P201
  COORDINATE FLOOR ELEVATION HEIGHT WITH G.C. SEE PLUMBING FIXTURE SCHEDULE ON
  SHEET P201. SEE SANITARY ISOMETRIC ON SHEET P201. SEE PLUMBING SPECIFICATIONS
  ON SHEET P901.
- 2. CAST-IN-PLACE CONCRETE TROUGH. PLUMBING CONNECTIONS, TRAP AND CLEANOUT BY P.C. COORDINATE INSTALLATION WITH G.C. SEE SANITARY ISOMETRIC ON SHEET P201.
- 3. P.C. SHALL PROVIDE AND INSTALL 4" COTG OUTSIDE BUILDING. SEE PLUMBING FIXTURE SCHEDULE AND CLEANOUT TO GRADE DETAIL '3' ON SHEET P201. PLUMBING SPECIFICATIONS ON SHEET P901
- 4. PROVIDE AND INSTALL TRAFFIC RATED OIL INTERCEPTOR EQUAL TO HANSON PIPE AND PRECAST MODEL 011500TRSC. SEE OIL INTERCEPTOR DETAIL '1' ON SHEET P201. SEE SANITARY ISOMETRIC ON SHEET P201.
- 5. ROUTE 3" VENT FROM OIL INTERCEPTOR TO EXTERIOR WALL, UP INTERIOR SIDE OF WALL, AND TERMINATE A MINIMUM OF 2'-0" ABOVE ROOF. ROOF PENETRATION SHALL BE A MINIMUM OF 5'-0" FROM EDGE OF ROOF. P.C. TO PROVIDE DEKTITE FLASHING AT PENETRATION. COORDINATE WITH G.C.
- 6. SUPPLY AND INSTALL FLOOR DRAIN PER MANUFACTURER'S RECOMMENDATION. COORDINATE WITH G.C. FOR TOP OF FIXTURE ELEVATION. ALL FLOOR DRAIN LOCATIONS SHALL BE COORDINATED WITH OWNER AND G.C. SEE SANITARY ISOMETRIC ON SHEET P201. SEE FIXTURE SCHEDULE ON SHEET P201. SEE SPECIFICATIONS ON SHEET P901.
- 7. ROUTE 3" VENT FROM SANITARY UP WALL AND TERMINATE A MINIMUM OF 2'-0" ABOVE ROOF. ROOF PENETRATION SHALL BE A MINIMUM OF 5'-0" FROM EDGE OF ROOF. P.C. TO PROVIDE DEKTITE FLASHING AT PENETRATION. COORDINATE WITH G.C.

- 8. EXISTING CLEANOUT-TO-GRADE TO REMAIN.
- 9. EXISTING FLOOR DRAIN TO REMAIN.

GARAGE 101

PARTS

109


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- 10. EXISTING SANITARY LINE TO REMAIN- FIELD LOCATE
- 11. TIE EXISTING SANITARY INTO NEW SANITARY AS REQUIRED. FIELD VERIFY DEPTH AND SIZE OF EXISTING SANITARY LINE PRIOR TO STARTING ANY WORK.
- 12. RELOCATED TWO COMPARTMENT UTILITY SINK AND FAUCET. ROUTE 1/2" DCW AND DHW TO FIXTURE AND INSTALL ANGLE SUPPLY STOPS.

#### P.C. GENERAL NOTES:

INSTALLATION.

- 1. COMPLY WITH ALL FEDERAL, STATE, AND LOCAL CODES, ORDINANCES, RULES AND REGULATIONS.
- PLACEMENT OF FIXTURES AND PIPE ROUTING SHALL BE COORDINATED WITH ARCHITECTURAL, MECHANICAL, AND ELECTRICAL DRAWINGS AND TRADES.
- 3. FIELD VERIFY LOCATION OF EQUIPMENT, FIXTURES, AND PIPING TO ENSURE NO INTERFERENCES WITH FIELD CONDITIONS.
- 4. ALL PLUMBING WORK SHALL BE COORDINATED WITH G.C. E.C. AND M.C. PRIOR TO
- 5. DRAWINGS ARE SCHEMATIC IN NATURE AND MAY NOT SHOW ALL ELEVATION CHANGES AND
- HORIZONTAL OFFSETS. CONTRACTOR SHALL FIELD ADJUST AS REQUIRED AND SHALL MINIMIZE OFFSETS WHERE POSSIBLE.
- 6. ALL EXISTING SANITARY LINE TO BE ABANDONED SHALL BE CAPPED AS REQ'D BELOW GRADE.

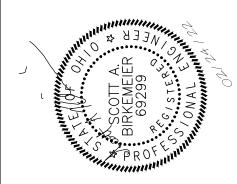

Design Group

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HENRY COUNTY HIGHWAY DEPT. 1343 BALES ROAD NAPOLEON, OHIO 43545

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PLUMBING FLOOR PLAN AND NOTES

ISSUED DATE

12-22-21 OWNER REVIEW
02-07-22 OWNER REVIEW
02-14-22 OWNER/CONTR REVIEW
02-24-22 FOR BIDS/PERMITS

DRAWN BY: JEM

CHECKED BY: SAB


DATE: 11-21


PLOT SCALE: 1:

JOB NO. 74-2724-21


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SANITARY ISOMETRIC, SCHEDULE AND DETAILS

ISSUED DATE 12-22-21 OWNER REVIEW
02-07-22 OWNER REVIEW
02-14-22 OWNER/CONTR REVIEW
02-24-22 FOR BIDS/PERMITS

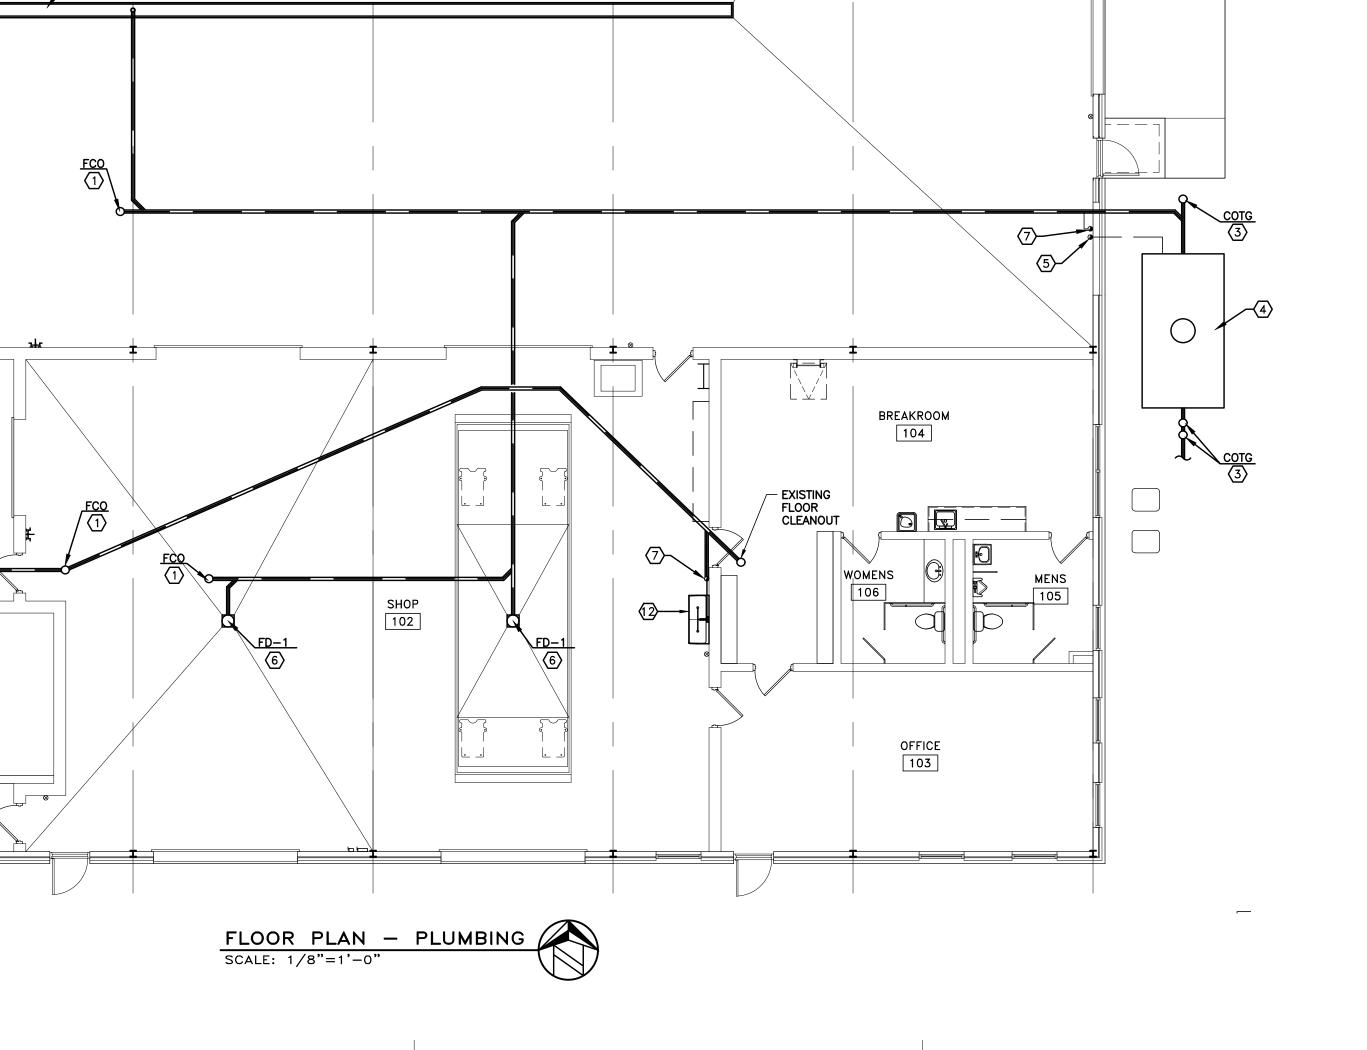DRAWN BY: SAB CHECKED BY: DATE:  $11 - 2^{\circ}$ PLOT SCALE:

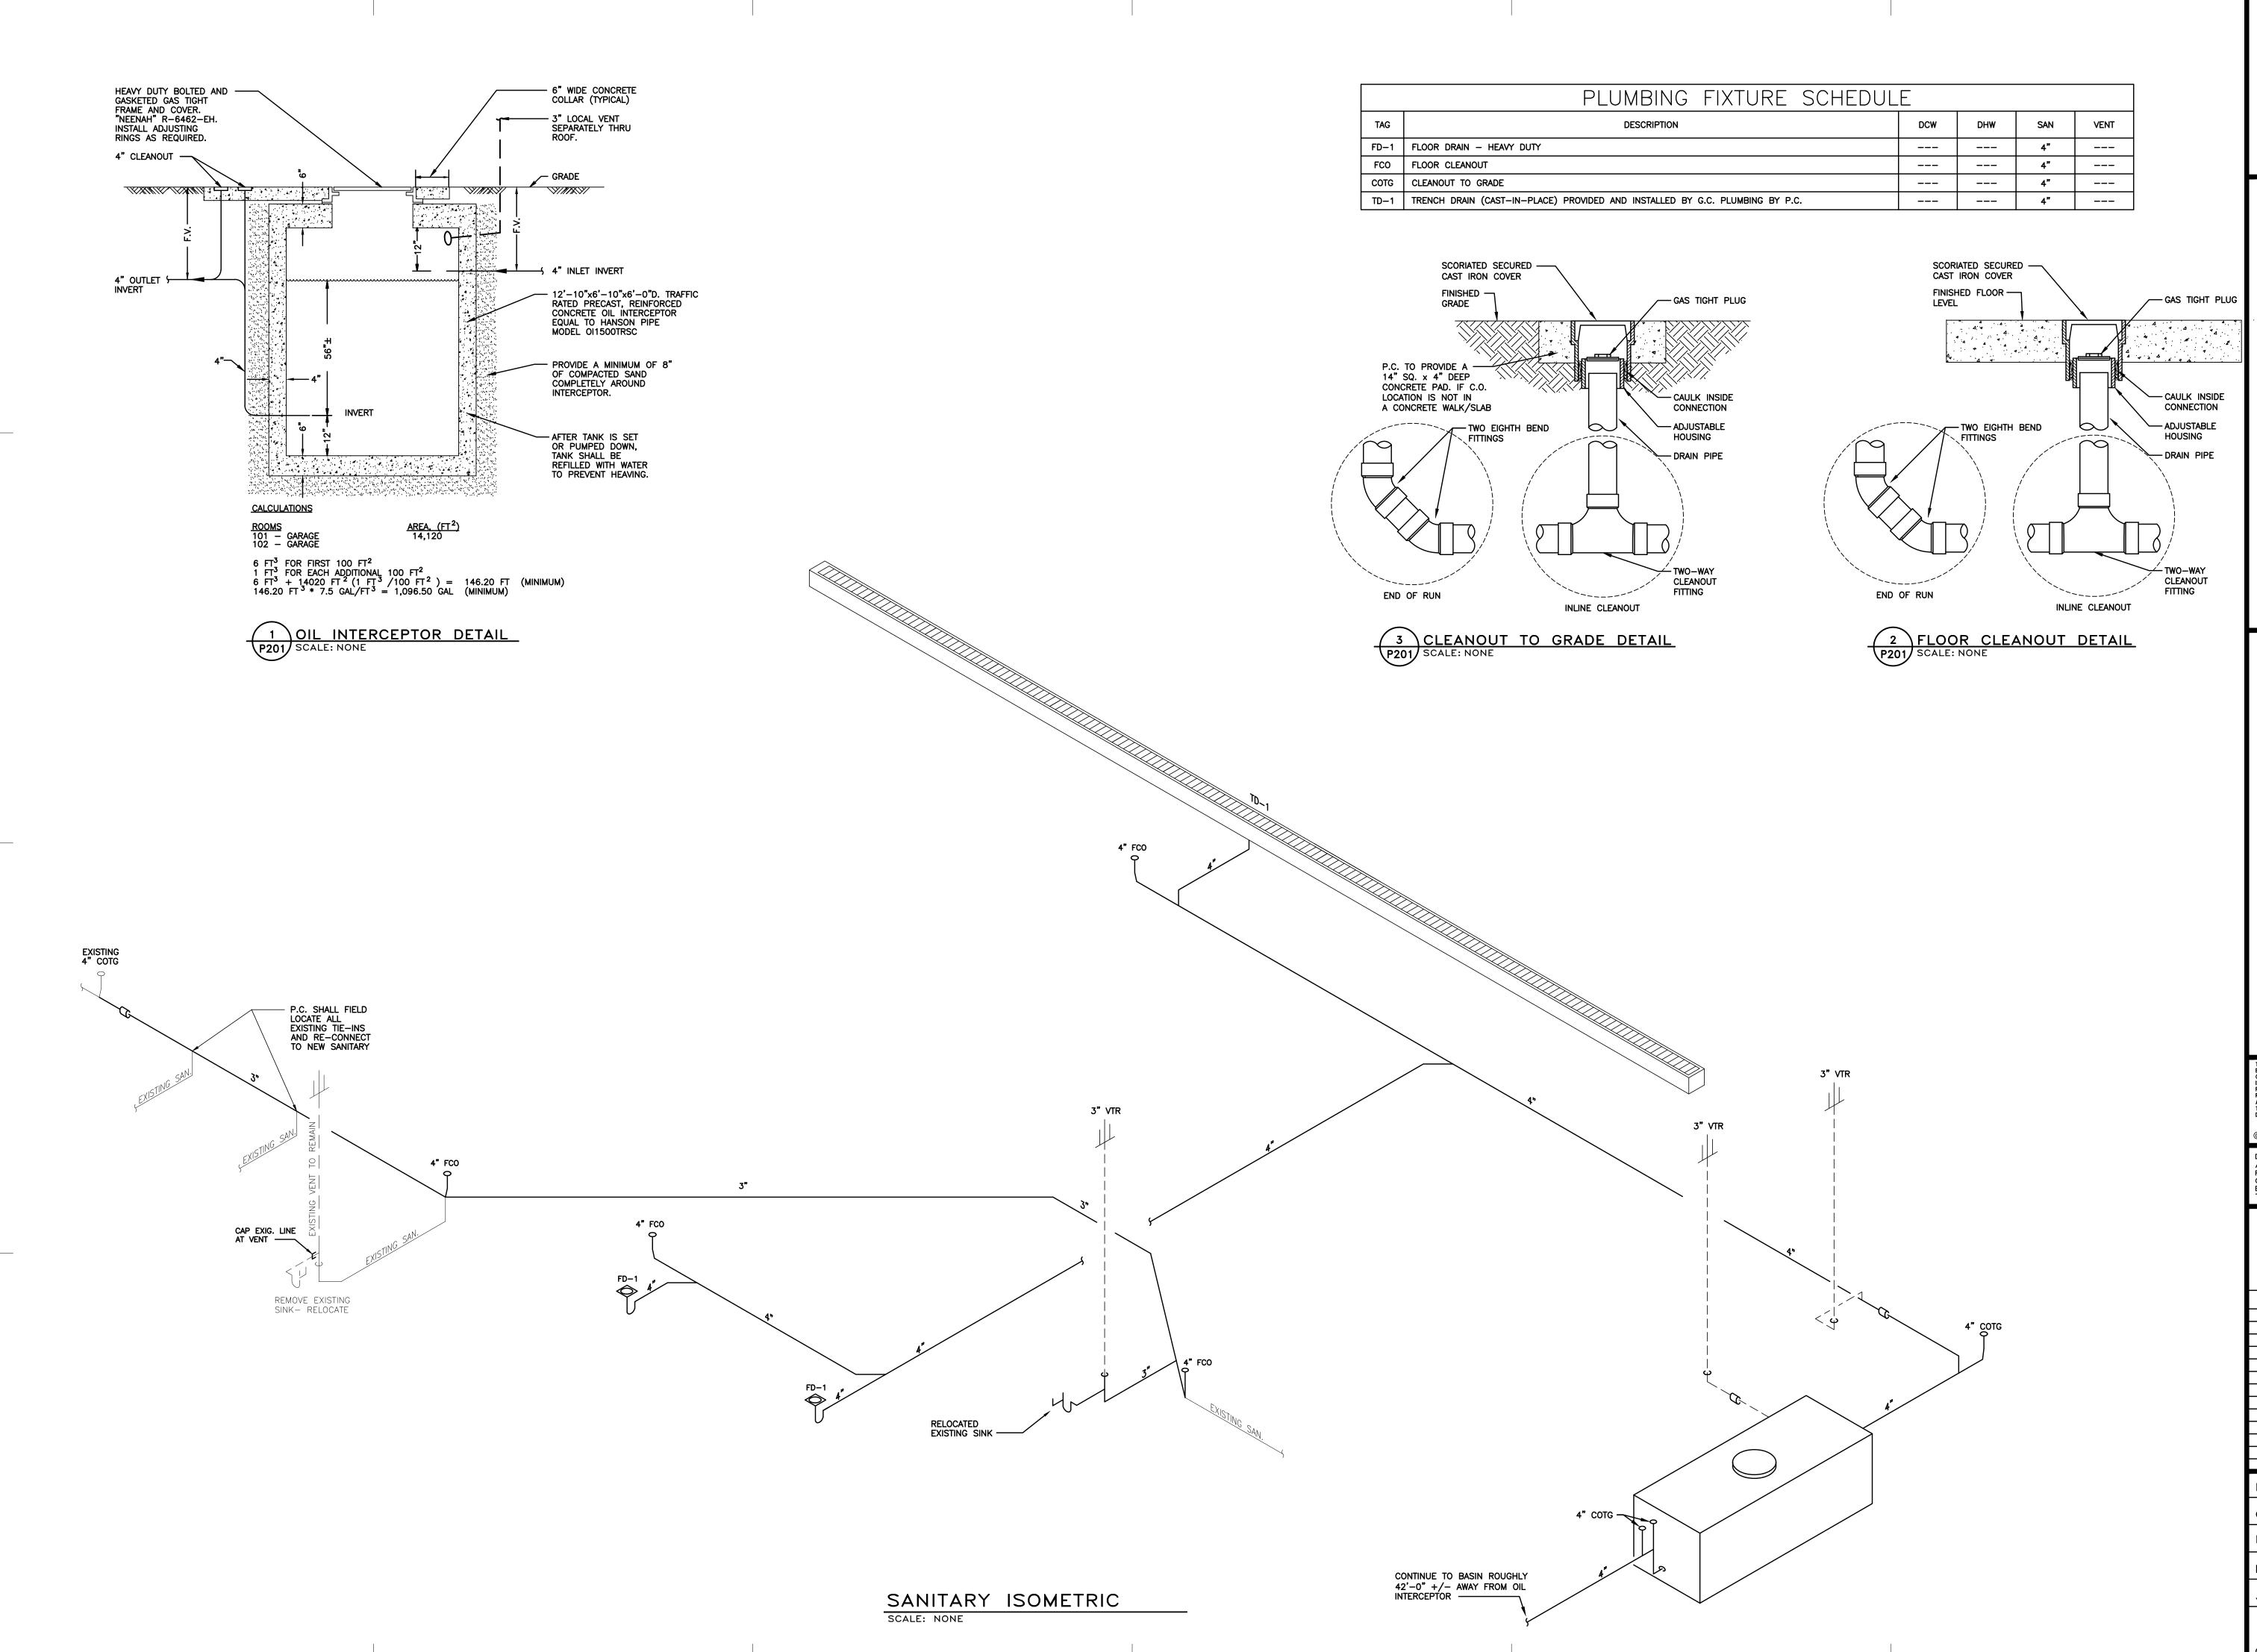JOB NO. 74-2724-21 SHEET P201 4 SHEETS

#### DIVISION 22 - PLUMBING SPECIFICATIONS

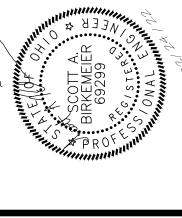
- 1. SCOPE OF WORK: WORK COVERED BY THESE SPECIFICATIONS AND DESIGN DRAWINGS SHALL INCLUDE ALL LABOR, MATERIALS, EQUIPMENT AND SERVICES NECESSARY FOR AND REASONABLY INCIDENTAL TO COMPLETE THE INSTALLATION OF THE PLUMBING SYSTEMS, INCLUDING SANITARY, DOMESTIC HOT AND COLD WATER, STORM, AND NATURAL GAS. NOTE: REFERENCE TO CONTRACTOR (OR P.C.) ON ALL PLUMBING DRAWINGS AND WITHIN THIS SPECIFICATION COVERS WORK FOR PLUMBING CONTRACTORS AND THEIR SUBCONTRACTORS.
- 2. <u>PERMITS AND CODES</u>: THE CONTRACTOR SHALL BE RESPONSIBLE FOR OBTAINING AND PAYING FOR BUILDING PERMITS. PLUMBING CONTRACTOR IS RESPONSIBLE FOR PLUMBING PERMIT AND ALL COSTS ASSOCIATED WITH INSPECTIONS, TAXES AND INSURANCE. ALL WORK SHALL BE INSTALLED TO CONFORM WITH ALL FEDERAL. STATE AND LOCAL CODES AND ORDINANCES INCLUDING, BUT NOT LIMITED TO HEALTH DEPARTMENT, EPA, NFPA, OMC 2017, OPC 2017, ASHRAE, ASTM, ASME, ANSI, UL, NEC, AMCA AND SMACNA.

- 4. <u>CONTRACT DRAWINGS</u>: IN GENERAL, DRAWINGS ARE SCHEMATIC IN NATURE AND ARE INTENDED AS A GUIDE FOR THE CONTRACTOR, BUT DO NOT NECESSARILY SHOW ALL DETAILS, OFFSETS, ELEVATION CHANGES, ETC. THE CONTRACTOR'S WORK SHALL CONFORM TO THE INFORMATION CONTAINED IN THIS SPECIFICATION AND/OR AS INDICATED IN THE LATEST REVISION OF THE DRAWINGS REFERRED TO HEREIN. THE TO PROCEEDING WITH FABRICATION OF THE WORK IN QUESTION. THE CONTRACTOR AT THEIR OWN EXPENSE. THE CONTRACTOR SHALL VERIFY ALL DIMENSIONS AND CHANGES ARE REQUIRED IN CONDUITS, PIPING RUNS, DRAINS, ETC. TO AVOID INTERFERENCE. MAJOR CHANGES SHALL NOT BE MADE WITHOUT THE APPROVAL OF MAY BE FOUND NECESSARY OR DESIRABLE TO AVOID INTERFERENCES. MAJOR REVISIONS SHALL BE VERIFIED WITH THE ENGINEER.
- 5. <u>VERIFICATION</u>: BEFORE RUNNING ANY PIPING, ETC., WITHIN THE BUILDING, THE CONTRACTOR SHALL ASSURE HIMSELF THAT THEY CAN BE INSTALLED AS CONTEMPLATED WITHOUT TRAPPING OR INTERFERING WITH COLUMNS, BEAMS, PIPING, FIXTURES, ETC. ANY NECESSARY MAJOR DEVIATION SHALL BE REFERRED TO THE OWNER FOR ADJUSTMENT BEFORE LINES ARE RUN, AT NO INCREASE IN CONTRACT PRICE. OPENINGS, SUPPORTING STEEL, FIELD-BUILT CURBS, ELECTRICAL DATA, SPACE REQUIREMENTS, ETC., WERE DESIGNED AROUND SPECIFIC PARAMETERS. WHEN THE CONTRACTOR DETERMINES THE MAKE OF EQUIPMENT TO BE PROVIDED FOR THE JOB, IT SHALL BE THEIR RESPONSIBILITY TO VERIFY AND COORDINATE UNIT DIMENSIONS WITH THE GENERAL CONTRACTOR AND ALL OTHER INTERESTED CONTRACTORS ON THE JOB. IT SHALL ALSO BECOME THE CONTRACTOR'S RESPONSIBILITY TO CHANGE AS NECESSARY, THROUGH THE ARCHITECT AND ENGINEER, ALL REQUIRED DIMENSIONS SO THAT OPENINGS, SUPPORTING STEEL, CURBS, ELECTRICAL DATA, ETC., WILL FIT THE EQUIPMENT SUPPLIED. ANY ADDITIONAL COST WILL BE THE SOLE RESPONSIBILITY OF THIS CONTRACTOR. IN ADDITION, ELECTRICAL POWER, INTERLOCK AND CONTROL DIAGRAMS AND PIPING ARRANGEMENTS WERE DESIGNED AROUND ONE SPECIFIC MANUFACTURER. IF ADDITIONAL WIRING PIPING CONTROLS, ETC. ARE REQUIRED FOR OTHER EQUIPMENT, THE CONTRACTOR SHALL INCLUDE THE COST OF THE SAME IN HIS PRICE. DIMENSIONS, ELEVATIONS AND RELATIVE LOCATIONS OF EXISTING EQUIPMENT, SEWERS, PIPES, DUCTS, CONDUITS, ETC., IN PLACE AS SHOWN ON THE DRAWINGS, ARE TAKEN FROM AS-BUILT AND/OR RECORD DRAWINGS AND ARE DEEMED RELIABLE ONLY IN SO FAR GENERAL LAYOUT IS CONCERNED. SUCH DIMENSIONS SHALL NOT BE USED FOR LAYOUT DRAWINGS NOR DETAILING OF COMPONENTS. THE RESPONSIBILITY FOR CHECKING IN PLACE ITEMS IS THE CONTRACTORS. ALL MEASUREMENTS. THE EXACT DETERMINATION OF RELATIVE ELEVATIONS OR LOCATIONS. THE ASCERTAINING OF ACCURACY OF ALL GIVEN ELEVATIONS AND OBTAINING ALL NECESSARY ADDITIONAL INFORMATION TO INSURE THE PROPER FIT AND COORDINATION OF ALL CONDUIT. EQUIPMENT, DUCTS, AND PIPING SHALL BE THE RESPONSIBILITY OF THE CONTRACTOR. THE CONTRACTOR SHALL CAREFULLY EXAMINE THE GENERAL BUILDING PLANS AND ALL MECHANICAL PLANS AND CARRY ON HIS WORK SO AS NOT TO DELAY OR INTERFERE WITH THE WORK OF OTHER TRADES. THE CONTRACTOR SHALL OBTAIN IN WRITING FROM OTHER CONTRACTORS SUCH DATA AS NECESSARY TO COORDINATE HIS WORK WITH
- AS BUILT DRAWINGS: THE CONTRACTOR SHALL NOTE CHANGES FROM CONTRACT DRAWINGS AND SPECIFICATIONS. THE CONTRACTOR SHALL NEATLY AND CORRECTLY ENTER IN RED PEN ANY DEVIATIONS ON DRAWINGS AFFECTED AND SHALL KEEP DRAWINGS AVAILABLE FOR INSPECTION. AN EXTRA SET OF DRAWINGS WILL BE FURNISHED FOR THIS PURPOSE. THE CONTRACTOR SHALL GIVE THE DRAWINGS TO THE OWNER AT PROJECT COMPLETION AND LABEL THEM "AS BUILT DRAWINGS -PLUMRING."
- 8. SUBMITTALS: SUBMIT TO THE ENGINEER FOR REVIEW FOR THE LIMITED PURPOSE OF CHECKING FOR CONFORMANCE WITH INFORMATION GIVEN AND THE DESIGN CONCEPT EXPRESSED IN THE CONTRACT DOCUMENTS SIX COPIES OF ALL PRODUCT DATA AND SHOP DRAWINGS FOR ALL SCHEDULED EQUIPMENT. CLEARLY IDENTIFY ALL SUBMITTALS WITH NAME SHOWN IN THE SCHEDULES. APPLY CONTRACTOR'S STAMP, SIGNED OR INITIALED CERTIFYING THAT REVIEW, APPROVAL, VERIFICATION OF PRODUCTS REQUIRED, FIELD DIMENSIONS, ADJACENT CONSTRUCTION WORK, AND COORDINATION OF INFORMATION IS IN ACCORDANCE WITH THE REQUIREMENTS OF THE WORK AND CONTRACT DOCUMENTS. IDENTIFY VARIATIONS FROM CONTRACT DOCUMENTS AND PRODUCT OR SYSTEM LIMITATIONS WHICH MAY BE DETRIMENTAL TO SUCCESSFUL PERFORMANCE OF THE COMPLETED WORK. DISTRIBUTE COPIES OF REVIEWED SUBMITTALS AS APPROPRIATE. INSTRUCT PARTIES TO PROMPTLY REPORT ANY INABILITY TO COMPLY WITH REQUIREMENTS.
- PRODUCT SUBSTITUTION: MANUFACTURERS SPECIFIED IN THE EQUIPMENT SCHEDULES AND SPECIFICATIONS BY NAMING ONE OR MORE MANUFACTURERS ARE INCLUDED AS A BASIS OF DESIGN WITH A PROVISION FOR SUBSTITUTIONS. SUBMIT A REQUEST FOR SUBSTITUTION FOR ANY MANUFACTURER NOT NAMED. DOCUMENT EACH REQUEST WITH COMPLETE DATA SUBSTANTIATING COMPLIANCE OF PROPOSED SUBSTITUTION WITH CONTRACT DOCUMENTS. A REQUEST FOR SUBSTITUTION CONSTITUTES A REPRESENTATION THAT THE SUBMITTER HAS INVESTIGATED PROPOSED PRODUCT AND DETERMINED THAT IT MEETS OR EXCEEDS THE QUALITY LEVEL OF THE SPECIFIED PRODUCT AND THAT IT WILL PROVIDE THE SAME WARRANTY FOR THE SUBSTITUTION AS FOR THE SPECIFIED PRODUCT. THE CONTRACTOR SHALL COORDINATE INSTALLATION AND MAKE CHANGES TO OTHER WORK WHICH MAY BE REQUIRED FOR THE WORK TO BE COMPLETED WITH NO ADDITIONAL COST TO THE OWNER. THE CONTRACTOR WAIVES CLAIMS FOR ADDITIONAL COSTS OR TIME EXTENSION WHICH MAY SUBSEQUENTLY BECOME APPARENT AND WILL REIMBURSE THE OWNER, ARCHITECT AND/OR ENGINEER FOR REVIEW OR REDESIGN SERVICES ASSOCIATED WITH RE-APPROVAL BY AUTHORITIES. SUBSTITUTIONS WILL NOT BE CONSIDERED WHEN THEY ARE INDICATED OR IMPLIED ON SHOP DRAWING OR PRODUCT DATA SUBMITTALS, WITHOUT SEPARATE WRITTEN REQUEST, OR WHEN ACCEPTANCE WILL REQUIRE REVISION TO THE CONTRACT DOCUMENTS.
- AND MATERIALS, THAT APPARATUS WILL DEVELOP CAPACITIES AND CHARACTERISTICS REQUIRED ON DRAWINGS. AND THAT IF DURING A PERIOD OF ONE YEAR AFTER DATE OF CERTIFICATE OF COMPLETION AND ACCEPTANCE OF PROJECT, ANY SUCH DEFECTS APPEAR, HE SHALL REMEDY SAME WITHOUT ANY COST TO THE OWNER. OBTAIN AND AS PART OF THE CONTRACT.
- 11. <u>CLOSE—OUT:</u> CONTRACTOR SHALL PROVIDE FIELD TESTING, CHECK—OUT AND SYSTEM DEMONSTRATIONS TO OWNER TO ASSURE PROPER PERFORMANCE AND ADJUSTMENT OF ITEMS PROVIDED UNDER THE CONTRACT. PROVIDE THREE BOUND COPIES OF SHOP DRAWING, MAINTENANCE PROCEDURES, OPERATION AND INSTRUCTION MANUALS. LITERATURE SUPPLIED WITH PLUMBING EQUIPMENT, AND A LIST OF ALL CONTRACTOR'S PURCHASE ORDERS WITH SUPPLIERS, NAMES, ADDRESSES AND PHONE NUMBERS, FOR ALL MATERIALS. PROVIDE INSTRUCTION TO PERSONNEL SELECTED BY THE OWNER. TO FAMILIARIZE THEM WITH THE LOCATION OF SIGNIFICANT EQUIPMENT, TRAIN THEM ON EQUIPMENT FUNCTIONS, REVIEW MAINTENANCE PROCEDURES AND COORDINATE INFORMATION AVAILABLE IN THE BINDER.

- 3. <u>QUALITY REQUIREMENTS</u>: THE CONTRACTOR SHALL MONITOR QUALITY CONTROL OVER SUPPLIERS, MANUFACTURERS, PRODUCTS, SERVICES, SITE CONDITIONS, AND WORKMANSHIP, TO PRODUCE WORK OF SPECIFIED QUALITY. THE CONTRACTOR SHALL COMPLY WITH MANUFACTURERS' INSTRUCTIONS. INCLUDING EACH STEP IN SEQUENCE. SHOULD MANUFACTURERS' INSTRUCTIONS CONFLICT WITH CONTRACT DOCUMENTS, REQUEST CLARIFICATION FROM ENGINEER BEFORE PROCEEDING. THE CONTRACTOR SHALL COMPLY WITH SPECIFIED STANDARDS AS MINIMUM QUALITY FOR THE WORK EXCEPT WHERE MORE STRINGENT TOLERANCES, CODES, OR SPECIFIED REQUIREMENTS INDICATE HIGHER STANDARDS OR MORE PRECISE WORKMANSHIP. THE CONTRACTOR SHALL HAVE WORK PERFORMED BY PERSONS QUALIFIED TO PRODUCE REQUIRED AND SPECIFIED QUALITY. THE CONTRACTOR SHALL VERIFY THAT FIELD MEASUREMENTS ARE AS INDICATED ON SHOP DRAWINGS OR AS INSTRUCTED BY THE MANUFACTURER. THE CONTRACTOR SHALL SECURE PRODUCTS IN PLACE WITH POSITIVE ANCHORAGE DEVICES DESIGNED AND SIZED TO WITHSTAND STRESSES, VIBRATION, PHYSICAL DISTORTION, AND DISFIGUREMENT.
- CONTRACTOR SHALL CONSULT WITH THE ENGINEER REGARDING ALL QUESTIONS PRIOR SHALL PREPARE ALL ADDITIONAL DETAIL OR FIELD INSTALLATION DRAWINGS NECESSARY CONDITIONS INDICATED ON THE ENGINEER'S LAYOUT DRAWINGS AND DETERMINE IF ANY THE ENGINEER. THE CONTRACTOR HAS THE RIGHT TO VARY THE RUN OF PIPING AS
- OTHER TRADES.
- 7. <u>SITE VISITS</u>: THE CONTRACTOR SHALL VISIT THE SITE (OR BUILDING) AND EXAMINE THE AREA OF WORK AND COMPARE IT WITH DRAWINGS AND SPECIFICATIONS, AND BE SATISFIED AS TO CONDITION OF PREMISES, SUCH AS OBSTRUCTIONS, ACTUAL LEVELS, AND OTHER NECESSARY REQUIREMENTS FOR CARRYING OUT THE WORK. ALL BIDDERS SHALL REPORT ANY DISCREPANCIES TO THE ARCHITECT PRIOR TO SUBMITTING THEIR BID OR PROPOSAL. NO ADDITIONAL COMPENSATION WILL BE GIVEN AFTER THE BIDS OR PROPOSALS HAVE BEEN SELECTED.

- 10. <u>WARRANTY</u>: THE MECHANICAL CONTRACTOR SHALL PROVIDE WRITTEN GUARANTEE TO THE OWNER THAT WORK HEREIN SHALL BE FREE FROM DEFECTS IN WORKMANSHIP SUBMIT TO THE OWNER ALL MANUFACTURERS' WARRANTIES FOR EQUIPMENT INSTALLED
- OPERATION AND MAINTENANCE MANUALS WHICH INCLUDES: COPIES OF EACH APPROVED

- 12. ADA COMPLIANCE: ALL FIXTURES, EQUIPMENT, CONTROLS AND DEVICES SHALL BE INSTALLED IN ACCORDANCE WITH THE REQUIREMENTS OF AMERICANS WITH DISABILITIES ACT (ADA) AND ANSI A117.1. STATE BUILDING CODE AND LOCAL CODES MAY APPLY.
- 13. <u>MATERIALS GENERAL</u>: THE MANUFACTURERS REFERENCED THROUGHOUT THESE OUTLINE SPECIFICATION ARE INCLUDED AS A BASIS OF DESIGN. SUBMISSION OF ALTERNATE MANUFACTURERS OF SIMILAR EQUIPMENT IS SUBJECT TO ENGINEERS APPROVAL. UNITS OF EQUIPMENT. OTHER THAN THOSE LISTED AS THE BASIS OF DESIGN, MUST BE PROVEN TO BE PHYSICALLY ACCEPTABLE, IN ADDITION TO MEETING ALL PERFORMANCE AND EQUIPMENT SPECIFICATIONS. LIABILITY OF NON-CONFORMANCE SHALL LIE ON CONTRACTOR/SUBMITTER.
- 14. <u>REFERENCED STANDARDS & QUALITY ASSURANCE:</u> ASME B31.9 "BUILDING SERVICES PIPING" FOR MATERIALS, PRODUCTS, AND INSTALLATION. SAFETY VESSELS SHALL BEAR THE APPROPRIATE ASME LABEL.
  - a. <u>2017 OPC-OHIO PLUMBING CODE</u>
  - NATIONAL RECOGNITION TESTING LABORATORY AND NEMA COMPLIANCE (NRTL): HANGERS, SUPPORTS AND COMPONENTS SHALL BE LISTED AND LABELED BY A NRTL WHERE USED FOR FIRE PROTECTION PIPING OSHA REGULATION 1910.7
  - c. NFPA-NATIONAL FIRE PROTECTION ASSOCIATION
  - QUALITY ASSURANCE: TESTING AND INSPECTION PROCEDURES ARE REQUIRED TO BE IMPLEMENTED ON THIS PROJECT AND SHALL COMPLY WITH ALL APPLICABLE PORTIONS OF ANSI B31.1, "CODE FOR PRESSURE PIPING" LATEST EDITION.
- 15. <u>PIPING GENERAL</u>: ALL PIPING SHALL BE INSTALLED PARALLEL WITH OR AT RIGHT ANGLES TO THE BUILDING WALLS AND WITH A PITCH OF ACCEPTED PIPING STANDARDS. ALL PIPING SHALL BE INSTALLED WITHOUT FORCING AND SHALL CLEAR ALL DOORS, DUCTWORK, AND OTHER BUILDING OBSTRUCTIONS.
- 16. <u>UNDERGROUND SANITARY WASTE PIPING</u>: UNDERGROUND SANITARY WASTE AND STORM PIPING SHALL BE SLOPED AS INDICATED IN 2017 OHIO PLUMBING CODE. PIPING SHALL
- A. ASPHALT-COATED SERVICE WEIGHT CAST IRON, NO-HUB PATTERN WITH HEAVY DUTY COUPLINGS UTILIZING 4 STAINLESS STEEL CLAMPS. COUPLINGS SHALL BE EQUAL TO HUSKY MODEL HD-2000.
- B. PLASTIC PVC, SCHEDULE 40 ASTM D2665-82, DWV WITH SOLVENT WELDED SOCKET JOINTS. INSTALLATION SHALL FOLLOW GUIDELINES IN ASTM D 2564-80 AND ASTM D
- 17. <u>ABOVE GROUND SANITARY WASTE & VENT PIPING INSIDE BUILDING</u>: ABOVE GROUND SANITARY WASTE AND VENT AND STORM PIPING SHALL BE SLOPED AS INDICATED IN 2017 OHIO PLUMBING CODE. PIPING SHALL BE AS FOLLOWS:
- A. ASPHALT-COATED SERVICE WEIGHT CAST IRON, NO-HUB PATTERN WITH HEAVY DUTY COUPLINGS UTILIZING 4 STAINLESS STEEL CLAMPS. COUPLINGS SHALL BE EQUAL TO HUSKY MODEL HD-2000.
- B. PLASTIC PVC, SCHEDULE 40 ASTM D2665-82, DWV WITH SOLVENT WELDED SOCKET JOINTS, INSTALLATION SHALL FOLLOW GUIDELINES IN ASTM D 2564-80 AND ASTM D 2665-82. (NOT PERMITTED IN RETURN AIR PLENUMS).
- 18. <u>TRAPS:</u> ALL FIXTURES REQUIRING TRAPS SHALL BE FURNISHED WITH HEAVY DUTY CHROME PLATED CAST BRASS TRAPS WITH CLEANOUT, TAIL PIECES AND TUBING DRAINS. AT HANDICAPPED LAVATORIES, PROVIDE OFFSET STRAINER/TAILPIECE AND EXTENSION AND INSTALL TRAP CLOSE AS POSSIBLE TO WALL. ROUGH-IN SANITARY OFF CENTER SO TRAP CAN BE INSTALLED PARALLEL TO WALL IF NECESSARY.
- 19. PLUMBING FIXTURES SHALL BE AS FOLLOWS. IT IS THE RESPONSIBILITY OF THE CONTRACTOR TO VERIFY THE LOCATION & MOUNTING HEIGHTS OF FIXTURES, ETC. WITH PLUMBING & ARCHITECTURAL DRAWINGS. ALL FIXTURES AND FACTORY SUPPLIED ACCESSORIES SHALL BE PROVIDED BY CONTRACTOR. CONTRACTOR SHALL PROVIDE ALL TRAPS, SUPPLY STOPS, RISERS, STRAINERS, ETC.
  - A. ACCEPTABLE MANUFACTURERS:
  - 1. MISCELLANEOUS TRIM (TRAPS, SUPPLIES, STRAINERS) DEARBORN BRASS, T&S BRASS, MCGUIRE, CHICAGO FAUCET, KOHLER, AMERIĆAN STANDARD, BRASS CRAFT,
  - 2. PLUMBING SPECIALTIES (DRAINS, CLEANOUTS, ETC.) ZURN, JOSAM, SMITH,
- B. FCO
- FLOOR CLEANOUTS SHALL BE EQUAL TO ZURN #ZN-1400-K "LEVEL-TROL" COMPLETE WITH DURA-COATED CAST IRON BODY, GAS AND WATERTIGHT ABS TAPERED—THREAD PLUG, AND ROUND SCORIATED POLISHED NICKEL BRONZE SECURED TOP. CLEANOUT BODY SHALL BE PROVIDED WITH ANCHOR FLANGE. SEE FLOOR CLEANOUT DETAIL '2' ON SHEET P201.
- CLEAN OUT TO GRADE SHALL BE EQUAL TO ZURN MODEL Z-1400-K-VP "LEVEL-TROL" WITH DURA-COATED CAST IRON BODY, GAS AND WATERTIGHT ABS TAPERED-THREAD PLUG, AND ROUND SCORIATED CAST IRON SECURED TOP. CLEANOUT BODY SHALL BE PROVIDED WITH ANCHOR FLANGE AND VANDAL RESISTANT SCREWS. SEE CLEANOUT TO GRADE DETAIL '3' ON SHEET P201.
- TRENCH DRAIN SHALL BE PROVIDED AND INSTALLED BY G.C. PLUMBING TO TRENCH DRAIN SHALL BE BY P.C. SEE ARCHITECTURAL AND STRUCTURAL DRAWINGS FOR DRAIN SPECIFICATIONS.
- E. FD-1
- FLOOR DRAIN SHALL BE EQUAL TO ZURN MODEL ZN-513. SQUARE TOP DRAIN, DURA-COATED CAST IRON DEEP SUMP BODY WITH BOTTOM OUTLET, SEEPAGE PAN AND COMBINATION FLASHING CLAMP AND FRAME FOR HINGED HEAVY- DUTY SLOTTED GRATE WITH SUSPENDED SEDIMENT BUCKET.

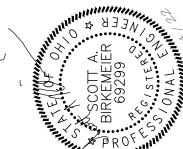

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PLUMBING **SPECIFICATIONS** 

ISSUED DATE

12-22-21 OWNER REVIEW 02-07-22 OWNER REVIEW 02-14-22 OWNER/CONTR REVIEW 02-24-22 FOR BIDS/PERMIT

| DRAWN BY:    | JEM    |  |  |  |
|--------------|--------|--|--|--|
| CHECKED BY:  | SAB    |  |  |  |
| DATE:        | 11-21  |  |  |  |
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